

BILL PAGE HONDA & WESTLAWN SHOPPING CENTER

MASON DISTRICT - FAIRFAX COUNTY, VIRGINIA

GENERALIZED DEVELOPMENT PLAN / PROFFER CONDITION AMENDMENT PLAN / SPECIAL EXCEPTION AMENDMENT PLAT
[TO AMEND RZ #2009-MA-011 AND SEA #95-M-039]

NOTES

- OWNER/APPLICANT:
BILL PAGE PLAZA, LLC.
6715 ARLINGTON BLVD.
FALLS CHURCH, VA 22042
- THIS PROPERTY IS IDENTIFIED ON THE FAIRFAX COUNTY TAX ASSESSMENT MAP AS 050-4-01, PARCELS 6 AND 7 AND 050-4-17, PARCELS H AND H-1, ZONED C-6. THE SITE ALSO LIES WITHIN THE HIGHWAY CORRIDOR OVERLAY DISTRICT (HCOD).
- THE TOTAL SITE AREA OF THE PROPERTY IS 364,252 SF OR 8.36 AC.
- A CATEGORY 5 SPECIAL EXCEPTION IS REQUIRED FOR THE VEHICLE SALES ESTABLISHMENT AND THE DRIVE-THRU PHARMACY. A CATEGORY 6 SPECIAL EXCEPTION IS REQUIRED FOR AN INCREASE IN BUILDING HEIGHT AND THE DRIVE-IN FINANCIAL INSTITUTION LOCATED WITHIN THE HCOD.
- TOPOGRAPHY AND EXISTING CONDITIONS TAKEN FROM A FIELD SURVEY DONE BY THIS FIRM, DATED FEBRUARY 14, 2005. CONTOUR INTERVAL IS TWO FEET.
- THERE ARE NO PROPOSED SPECIAL AMENITIES FOR THIS PROPERTY.
- THIS PROPERTY IS SERVED BY PUBLIC WATER AND SEWER.
- THERE IS NO OBSERVABLE EVIDENCE OF GRAVE SITES OR BURIAL GROUNDS ON THIS PROPERTY.
- THERE ARE NO PUBLIC FACILITIES PROPOSED WITH THIS PROPERTY.
- TO THE BEST OF OUR KNOWLEDGE ALL UTILITY EASEMENTS HAVING A WIDTH OF 25 FEET OR MORE ARE SHOWN.
- A REVIEW OF THE FEDERAL EMERGENCY MANAGEMENT AGENCY'S FLOOD INSURANCE RATE MAP, COMMUNITY PANEL #515525 0087 D, REVISED MARCH 5, 1990, DESIGNATES A PORTION OF THE PROPERTY AS BEING IN A SPECIAL FLOOD HAZARD AREA, ZONE AE. AREAS DETERMINED TO BE INUNDATED BY THE 100-YEAR FLOOD, A PORTION OF THE PROPERTY AS BEING IN ZONE X, AREAS OF 100-YEAR FLOOD WITH AVERAGE DEPTHS OF LESS THAN 1 FOOT, AND THE REMAINDER OF THE SITE AS BEING IN ZONE X, AREAS DETERMINED TO BE OUTSIDE THE 500-YEAR FLOOD PLAIN.
- LIMITS OF RESOURCE PROTECTION AREA (RPA) SHOWN ARE FROM RPA PLAN #5934-RPA-001-1 PREPARED BY WETLAND STUDIES & SOLUTIONS, INC. AND APPROVED BY FAIRFAX COUNTY ON MAY 14, 2007.
- ALL EXISTING ON-SITE BUILDINGS AND STRUCTURES TO BE REMOVED UNLESS OTHERWISE NOTED.
- IN ACCORDANCE WITH THE FAIRFAX COUNTY COMPREHENSIVE TRAIL PLAN, A 10' PAVED TRAIL IS PROPOSED ALONG ARLINGTON BOULEVARD AND ANNANDALE ROAD.
- THE PROPOSED REDEVELOPMENT WILL RESULT IN A REDUCTION OF IMPERVIOUS AREA WITHIN THE RPA.
- THERE ARE NO MAJOR SANITARY SEWER IMPROVEMENTS PROPOSED WITH THIS APPLICATION.
- PER THE FAIRFAX COUNTY ZONING ORDINANCE, A FINANCIAL INSTITUTION WITH DRIVE THRU WINDOWS MAY HAVE 5 STACKING SPACES IN FRONT OF EACH OF THE FIRST TWO WINDOWS, PROVIDED THAT BOTH WINDOWS REMAIN OPEN WHEN THE DRIVE THRU FACILITY IS OPERATIONAL.
- THERE ARE NO SCENIC ASSETS OR NATURAL FEATURES ON-SITE DESERVING OF PROTECTION OR PRESERVATION. THE PROPOSED REDEVELOPMENT OF THE SITE DOES NOT PROPOSE ANY CHANGES TO TRIPPS RUN.
- IT IS ANTICIPATED THAT CONSTRUCTION WILL BEGIN FOLLOWING RECEIPT OF ALL NECESSARY COUNTY APPROVALS. PHASING WILL BE DETERMINED AT TIME OF SITE PLAN.
- EXCEPT AS NOTED IN THE MODIFICATIONS/WAIVERS REQUESTED, THE PROPOSED DEVELOPMENT CONFORMS TO THE PROVISIONS OF ALL APPLICABLE ORDINANCES, REGULATIONS, AND ADOPTED STANDARDS.
- APPLICANT RESERVES THE RIGHT TO OPERATE AND MAINTAIN ALL OR A PORTION OF THE EXISTING DEALERSHIP UNTIL READY TO PROCEED WITH PROPOSED REDEVELOPMENT. THE EXISTING DEALERSHIP WILL REMAIN OPEN AND OPERATING DURING CONSTRUCTION OF THE NEW DEALERSHIP.
- ONE CAR WASH ANCILLARY TO THE DEALERSHIP WILL BE INCLUDED, AS SHOWN ON THE PLAN.
- ADVANCE DENSITY CREDIT IS RESERVED IN ACCORDANCE WITH THE PROVISIONS OF THE FAIRFAX COUNTY ZONING ORDINANCE, FOR ALL ELIGIBLE DEDICATIONS DESCRIBED HEREIN OR AS MAY BE REQUIRED BY FAIRFAX COUNTY OR VDOT PURSUANT TO THE PUBLIC FACILITIES MANUAL ("PFM"), AT THE TIME OF SITE PLAN APPROVAL FOR THE PROPERTY.
- ALL FREESTANDING SIGNS WILL BE INTERNALLY LIT AND WILL COMPLY WITH ALL PROVISIONS OF ARTICLE 12 OF THE ZONING ORDINANCE. THE FREESTANDING SIGN ALONG ANNANDALE ROAD SHALL BE A MAXIMUM OF 18 FEET IN HEIGHT AND A MAXIMUM SIGN AREA OF 65 SQUARE FEET.
- TO THE BEST OF OUR KNOWLEDGE, THERE ARE NO HAZARDOUS OR TOXIC SUBSTANCES ON SITE.

WAIVERS AND MODIFICATIONS REQUESTED

- A WAIVER OF THE TRANSITIONAL SCREENING YARD REQUIREMENT ADJACENT TO THE SINGLE FAMILY HOMES DUE TO THE EXISTING CONCRETE TRIPPS RUN CHANNEL AND STORM SEWER EASEMENT IS REQUESTED.
- A WAIVER OF THE BARRIER REQUIREMENT ADJACENT TO THE SINGLE FAMILY HOMES TO ALLOW THE EXISTING FENCES TO REMAIN IS REQUESTED.
- A WAIVER OF INTERPARCEL ACCESS ALONG ANNANDALE ROAD DUE TO THE EXISTING TRIPPS RUN AND ADJACENT RESIDENTIAL LAND IS REQUESTED.
- A WAIVER OF THE SERVICE DRIVE REQUIREMENT ALONG ARLINGTON BOULEVARD IS REQUESTED TO PROVIDE A ONE-WAY SERVICE DRIVE, IF APPROVED, OR REMOVAL OF THE SERVICE DRIVE.
- A WAIVER OF THE ON ROAD BIKE ROUTE LANE ON ARLINGTON BOULEVARD IS REQUESTED.
- A WAIVER OF THE MINOR PAVED TRAIL REQUIREMENT ALONG TRIPPS RUN IS REQUESTED.
- A WAIVER OF THE PERIPHERAL PARKING LOT LANDSCAPING REQUIREMENT ADJACENT TO PARCEL 50-1-17-6, DUE TO THE EXISTING COUNTY STORM PIPE IS REQUESTED.
- A MODIFICATION OF THE PERIPHERAL PARKING LOT LANDSCAPING ALONG ARLINGTON BOULEVARD IS REQUESTED.

AREA TABULATION

TOTAL SITE AREA: ±364,252 SF/±8.36 AC
PROP. R.O.W. DEDICATION AREA = ±8,680 SF/±0.20 AC

PROP. BUILDING AREA:

PROP. DEALERSHIP	=	±60,000 SF
PROP. RETAIL	=	±20,000 SF
PROP. PHARMACY	=	±15,000 SF
PROP. FINANCIAL INSTITUTION	=	±5,000 SF

TOTAL PROP. BUILDING AREA = ±100,000 SF
PROP. F.A.R. = ±0.28*
(* FAR BASED ON PRE-DEDICATION AREA)

ZONING TABULATION

PROP. ZONE: C-6, COMMUNITY RETAIL COMMERCIAL DISTRICT

	REQUIRED	PROVIDED
MIN. LOT AREA	40,000 SF	±364,253 SF/±8.36 AC
MIN. LOT WIDTH	200 FT	±505 FT
MAX. BLD. HT.*	40 FT	±50 FT*
MIN. YARD REQUIREMENTS		
FRONT	45' ABP, 40 FT	±59 FT, ±62 FT
SIDE	NONE	N/A
REAR	20 FT	±117 FT
MAX. FAR**	0.40	±0.28**
OPEN SPACE	15%	±20%

* A SPECIAL EXCEPTION FOR AN INCREASE IN BLDG. HEIGHT IS REQUESTED WITH THIS PLAT.
** FAR BASED ON PRE-DEDICATION AREA

PARKING TABULATION

USE: SHOPPING CENTER *
RATE: 4.3 SPACES/1,000 SF OF GFA
(±40,000/1,000 x 4.3 = 172)

USE: VEHICLE SALE, RENTAL, AND ANCILLARY SERVICE ESTABLISHMENT
RATE: 1 SPACE PER 500 SF OF ENCLOSED SALES/RENTAL FLOOR AREA, PLUS 1 SPACE PER 2500 SF OF OPEN SALES/RENTAL DISPLAY LOT AREA, PLUS 2 SPACES PER SERVICE BAY AND 1 SPACE PER EMPLOYEE, BUT NOT LESS THAN 5 SPACES


ENCLOSED SALES/RETAIL:	±10,000/500 = 20 SPACES
OPEN SALES/RENTAL DISPLAY:	±5,000/2500 = 2 SPACES
SERVICE BAYS:	2 X 30 BAYS = 60 SPACES
EMPLOYEES:	115 EMP. = 115 SPACES
	197 SPACES

TOTAL PARKING REQUIRED (ENTIRE SITE) = 369 SPACES

PARKING PROVIDED

SURFACE SPACES = 201
STRUCTURE SPACES = 190
TOTAL PARKING SPACES = 391 (INCL. 10 HC) **


* INCLUDES RETAIL, PHARMACY, AND FINANCIAL INSTITUTION. SQUARE FOOTAGE MAY INCLUDE ADDITIONAL USES NOT CURRENTLY SHOWN ON THIS PLAN.
** ADDITIONAL PARKING AREA PROVIDED IN STRUCTURE FOR VEHICLE STORAGE

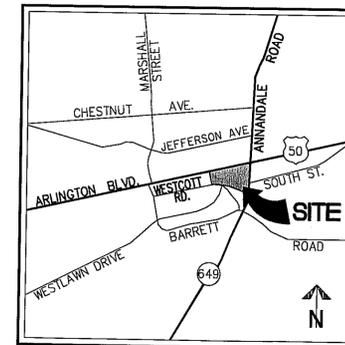

VICINITY MAP


SCALE: 1"=2000'

ANGLE OF BULK PLANE DETAIL ANNANDALE ROAD

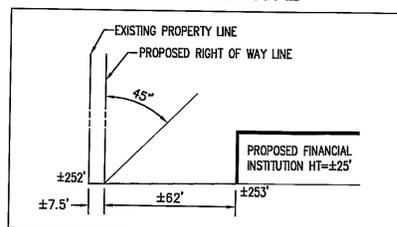

(SCALE 1"=40')

ANGLE OF BULK PLANE DETAIL ARLINGTON BOULEVARD

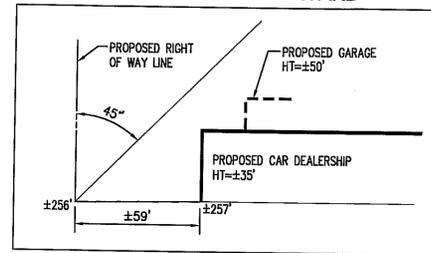

(SCALE 1"=40')

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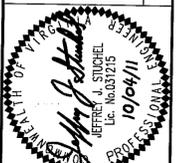
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Department of Planning & Zoning
OCT 04 2011
Zoning Evaluation Division

Application No SEA 95-M-039-02 Staff M.B.
APPROVED (SE) (SP) PLAN

SEE DEV CONDS DATED 10/04/2011
Date of (BOS) (BZA) Approval 10/18/2011
Sheet 1 of 21

Concurr. With PCA 2009-MA-011

WALTER L. PHILLIPS
INCORPORATED
DATE: 8/11/11; REV: 7/28/2011; 8/18/2011; 8/20/11; 10/4/11
DRAWN: MRW
CHECKED: JS



NO.	DESCRIPTION	DATE	REV. BY	APPROVED

COVER SHEET
BILL PAGE HONDA & WESTLAWN SHOPPING CENTER
MASON DISTRICT
FAIRFAX COUNTY, VIRGINIA

EXISTING VEGETATION MAP INFORMATION						
KEY	COVER TYPE	PRIMARY SPECIES	SUCCESSIONAL STAGE	CONDITION	ACREAGE	COMMENTS
A	OPEN FIELD/ (MAINTAINED GRASSLANDS)			FAIR	5,100 SF .13 AC	GRASS/HERBACEOUS MATERIAL, SOMEWHAT MAINTAINED BY SEASONAL MOWING
B	BOTTOMLAND FOREST	WHITE PINE, ELM, ASH, POPLAR, MAPLE	SUB-CLIMAX	FAIR	19,850 SF .46 AC	INVASIVE PLANT MATERIAL - INCLUDING MULTIFLORA ROSE, WILD GRAPE, HONEYSUCKLE - MODERATE
C	EARLY SUCCESSIONAL FOREST COMMUNITY	CEDAR, ASH, MAPLE	SUB-CLIMAX	POOR	17,100 SF .41 AC	ALONG RIP-RAP SECTION OF CREEK, INVASIVE PLANTS INCLUDE MIMOSA, WILD GRAPE, HONEYSUCKLE, MULTIFLORA ROSE - EXTENSIVE
D	DEVELOPED LAND				321,002 SF 7.36 AC	EXISTING BUILDINGS, WALKS, ASPHALT
TOTAL:					364,252 SF 8.36 AC	

PARCEL KEY	
TAX MAP #	EX. ZONE
050-4-01-0006	C-6
050-4-01-0007	C-6
050-4-17-H	C-6
050-4-17-H-1	C-6

CURVE TABLE

CURVE	RADIUS	LENGTH	DELTA	TANGENT	CHORD	CHORD BEARING
C1	18.50'	33.28'	103°04'25"	23.29'	28.97'	S50°19'13"E
C2	1,236.80'	130.90'	8°03'51"	65.51'	130.84'	S02°48'56"E
C2A	1,236.80'	81.36'	3°46'09"	40.70'	81.35'	S01°40'05"E
C2B	1,236.80'	49.54'	2°17'42"	24.77'	49.53'	S04°42'01"E
C3	1,175.66'	52.87'	2°34'35"	26.44'	52.86'	S04°33'34"E
C4	444.47'	184.11'	23°44'00"	93.39'	182.80'	S12°04'38"W
C4A	444.47'	93.82'	12°05'37"	47.08'	93.64'	S06°15'27"W
C4B	444.47'	90.29'	11°38'23"	45.30'	90.14'	S18°07'27"W

LEGEND

- AC..... AIR CONDITIONER
- APPROX. LOC..... APPROXIMATE LOCATION
- CO..... CLEANOUT
- CONC..... CONCRETE
- CONST..... CONSTRUCTION
- DB..... DEED BOOK
- EC..... EDGE OF CONCRETE
- EG..... EDGE OF GRAVEL
- EP..... EDGE OF PAVEMENT
- ESMT..... EASEMENT
- FC..... FIRE CURB
- FDC..... FIRE DEPARTMENT CONNECTION
- FF..... FIRST/FINISH FLOOR
- GM..... GAS METER
- GV..... GAS VALVE
- HC..... HANDICAPPED RAMP
- INV..... INVERT
- IPF..... IRON PIPE FOUND
- IPS..... IRON PIPE SET
- N/F..... NOW OR FORMERLY
- OH..... OVERHANG/CANOPY
- PG..... PAGE
- RD..... ROOF DRAIN
- RET..... RETAINING WALL
- RPA..... RESOURCE PROTECTION AREA
- SD..... STORM SEWER STRUCTURE
- SS..... SANITARY SEWER STRUCTURE
- SW..... SIDEWALK
- TCB..... TRAFFIC CONTROL BOX
- TEMP..... TEMPORARY
- WM..... WATER METER
- WV..... WATER VALVE
- WH..... FIRE HYDRANT
- WD..... DOORWAY/ENTRANCE
- UP..... UTILITY POLE
- LP..... LIGHT POLE
- TM..... TELEPHONE MANHOLE
- TP..... TELEPHONE PEDESTAL
- F..... FENCE
- GW..... GUY WIRE
- OW..... OVERHEAD WIRES
- UGL..... UNDERGROUND GAS LINE
- UTL..... UNDERGROUND TELEPHONE LINE
- UU..... UNDERGROUND UTILITY LINE
- UWL..... UNDERGROUND WATER LINE
- T..... TREE
- TL..... LIMITS OF TREE CANOPY/VEGETATION
- CG..... CURB AND GUTTER
- B..... BOLLARD
- ET..... ELECTRIC TRANSFORMER
- SE..... SPOT ELEVATION
- S..... SIGN


LIMIT OF CONCRETE CHANNEL/JURISDICTIONAL LIMIT OF PERENNIAL STREAM PER WSSI AND USACE JURISDICTIONAL DETERMINATION.

LIMITS OF RPA PREPARED BY WSSI (PER APPROVED RPA PLAN #5634-RPA-001-1)

LIMITS OF 100-YEAR MAJOR FLOODPLAIN PER APPROVED RPA PLAN 5943-RPA-001-1 BY WSSI.

INVASIVE PLANT MATERIAL - MULTIFLORA ROSE, HONEYSUCKLE, AMPPELOPSIS, ENGLISH IVY, MIMOSA, WILD GRAPE

REMOVE INVASIVE PLANT MATERIAL WITHIN RIP-RAP SECTION OF STREAM BY CUTTING AND TREATING WITH HERBICIDE AS RECOMMENDED BY VA. CERTIFIED APPLICATOR. REVEGETATE WITH PLUGS OF HERBACEOUS NATIVE PLANT MATERIAL, AND SHRUB/PLUSS WHERE THERE IS ENOUGH ORGANIC MATERIAL TO SUPPORT ADDITIONAL PLANTING. THIS AREA IS WITHIN A STORM SEWER EASEMENT, THEREFORE, ALL PROPOSED PLANTINGS ARE SUBJECT TO COUNTY APPROVAL.

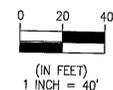

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WALTER L. PHILLIPS
INCORPORATED
ESTABLISHED 1945
DATE: 9/10/11; REV: 7/26/2011; 9/16/2011; 9/30/11; 10/4/11

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DRAWN: DRW

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10/04/11
WALTER L. PHILLIPS
REGISTERED PROFESSIONAL ENGINEER
LICENSE NO. 031215

EXISTING CONDITIONS EXHIBIT / EXISTING VEGETATION MAP

BILL PAGE HONDA & WESTLAWN SHOPPING CENTER
MASON DISTRICT
FAIRFAX COUNTY, VIRGINIA

Application No SEA 95-M-039-02 Staff M.B.
APPROVER (SE) (SP) PLAN
SEE DEV CONDS DATED 10/04/2011
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Sheet 2 of 21
Concurr. With PCA 2009-MA-011

SHEET: 2 OF 21

TREE COVER CALCULATIONS

TOTAL SITE AREA	±364,252 S.F.
R.O.W. DEDICATION	- ±8,370 S.F.
FLOODPLAIN AREA	- ±54,618 S.F.
ADJUSTED SITE AREA	±301,264 S.F.
PERCENT REQUIRED	X 10 %
TREE COVER REQUIRED	±30,126 S.F.
TREE COVER PROVIDED (PLANTED)	±34,100 S.F.
EXISTING TREE COVERAGE	+ 0 S.F.
TOTAL TREE COVERAGE	±34,100 S.F. (±11%)

TABLE 12.3

TABLE 12.3 TREE PRESERVATION TARGET CALCULATIONS AND STATEMENT


- PRE-DEVELOPMENT AREA OF EXISTING TREE CANOPY (FROM EVM): 37,550 SF
AREA OF EXISTING TREES OUTSIDE FLOODPLAIN/STORM EASEMENT AREA: 300 SF
- PERCENTAGE OF GROSS SITE AREA COVERED BY EXISTING TREE CANOPY: <1%
(TOTAL ADJUSTED SITE AREA = 307,634 SF)
- PERCENTAGE OF 10-YEAR TREE CANOPY REQUIRED FOR SITE: 10% (35,636 SF)
(INCLUDING RPA/FLOOD PLAIN AREA)
- PERCENTAGE OF 10 YEAR TREE CANOPY REQUIREMENT THAT SHOULD BE MET THROUGH TREE PRESERVATION: (35,636 * 1%)
1% = 356 SF
*NOTE THESE TREES ARE BRADFORD PEARS AND NOT CANDIDATES FOR PRESERVATION ADJUSTED TARGET OUTSIDE OF STORM SEWER AND FLOODPLAIN - 0%
- PROPOSED PERCENTAGE OF CANOPY REQUIREMENT THAT WILL BE MET THROUGH TREE PRESERVATION: 0 SF 100 %
- HAS THE TREE PRESERVATION TARGET MINIMUM BEEN MET? YES

PROPOSED TREE CALCULATIONS

CATEGORY IV TREES ±99 @ 200 SF	±19,800 SF
2-2.5" CALIPER REPRESENTATIVE TREE TYPES: ACER RUBRUM, PLATANUS ACERIFOLIA, QUERCUS PHELLOS, QUERCUS RUBRA, TILIA AMERICANA	
CATEGORY II TREES ±31 @ 100 SF	±3,100 SF
2-2.5" CALIPER REPRESENTATIVE TREE TYPES: AMELANCHIER ARBorea, AMELANCHIER CANADENSIS, CERCIS CANADENSIS, CHIONANTHUS VIRGINICUS, CORNUS MAS, HALEZIA CAROLINIANA, MAGNOLIA VIRGINIANA, OXYDENDRUM ARBOREUM	
CATEGORY IV EVERGREEN TREES ±16 @ 200	±3,200 SF
8-10' HEIGHT REPRESENTATIVE TREE TYPES: MAGNOLIA GRANDIFLORA	
CATEGORY II EVERGREEN TREES ±80 @ 100	±8,000 SF
8-10' HEIGHT REPRESENTATIVE TREE TYPES: ILEX OPACA, JUNIPERUS VIRGINIANA, PINUS BUNGEANA, PICEA OMORIKA	
TOTAL PLANTED TREE COVERAGE:	±34,100 SF

INTERIOR PARKING LOT LANDSCAPING CALCULATIONS

TOTAL PARKING AREA (INCL. SURFACE OF PARKING GARAGE)	X ±161,852 S.F.	5 %
REQUIRED	±8,093 S.F.	
PROPOSED	±9,400 S.F. (47 TREES @ 200 SF)	

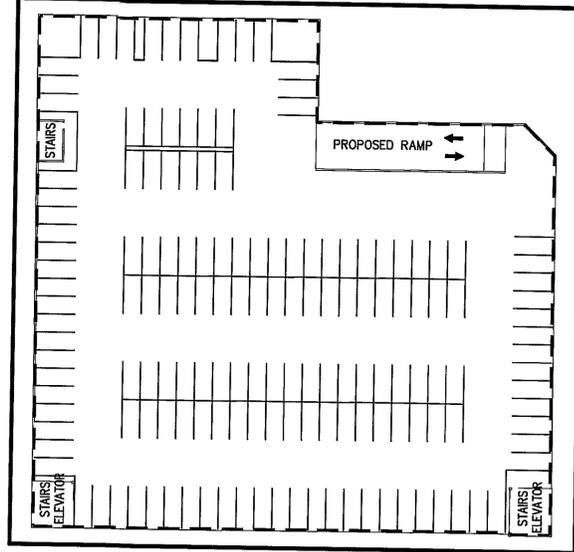

LANDSCAPE LEGEND


- PROPOSED DECIDUOUS TREES
- PROPOSED DECIDUOUS TREES (COUNTED TOWARDS INTERIOR PARKING LOT LANDSCAPING)
- PROPOSED DECIDUOUS TREES (COUNTED TOWARDS PERIPHERAL PARKING LOT LANDSCAPING)
- PROPOSED MEDIUM DECIDUOUS/ORNAMENTAL TREES/FILTERRA
- PROPOSED EVERGREEN TREES
- PROPOSED DECORATIVE PLANTINGS
- EXISTING TREE COVER TO REMAIN. TREES WITHIN A STORM SEWER OR SANITARY SEWER EASEMENT HAVE NO CREDIT TAKEN.

PERIPHERAL PARKING LOT LANDSCAPING CALCULATIONS

FRONT PERIPHERAL PARKING LOT REQ. 1 SHADE TREE/40 LF
1,130'/40 = 28.25 OR 29 REQ.
32 PROVIDED


NOTES

- ALL PLANTINGS SHOWN ARE SCHEMATIC AND PRELIMINARY IN NATURE. THEY ARE SUBJECT TO ADJUSTMENT AT TIME OF SITE PLAN.
- REMOVE SECTIONS OF CHAIN LINK FENCE, CONNECTING WOOD FENCE IN NEW/GOOD CONDITION WITH SIMILAR 6-7" BOARD ON BOARD FENCE FOR ADDITIONAL SCREENING OF RESIDENTIAL NEIGHBORHOOD. REMOVE CHAIN LINK FENCE WHERE IT OVERLAPS WOOD FENCE INSTALLED BY RESIDENCES AS IT CREATES AN AREA FOR INVASIVE PLANT MATERIAL AND DEBRIS TO ACCUMULATE.
- REMOVE ALL DEBRIS FROM RESIDENTIAL NEIGHBORHOOD (YARD DEBRIS, BRANCHES, LITTER) WITHIN THE LIMITS OF TREE PRESERVATION USING HAND METHODS SEE TREE NARRATIVE
- LIMIT OF CONCRETE CHANNEL/JURISDICTIONAL LIMIT OF PERENNIAL STREAM PER WSSI AND USACE JURISDICTIONAL DETERMINATION.
- ANY TREES IN FLOODPLAIN, STORM SEWER OR SANITARY SEWER EASEMENT AREA WILL NOT HAVE ANY TREE COVER CREDIT TAKEN. IN ADDITION, THEY WILL BE FIELD LOCATED AFTER REMOVAL OF INVASIVE SPECIES AND ANY DEAD TREES TO BE REMOVED. THIS WILL BE DETERMINED AT SITE PLAN.

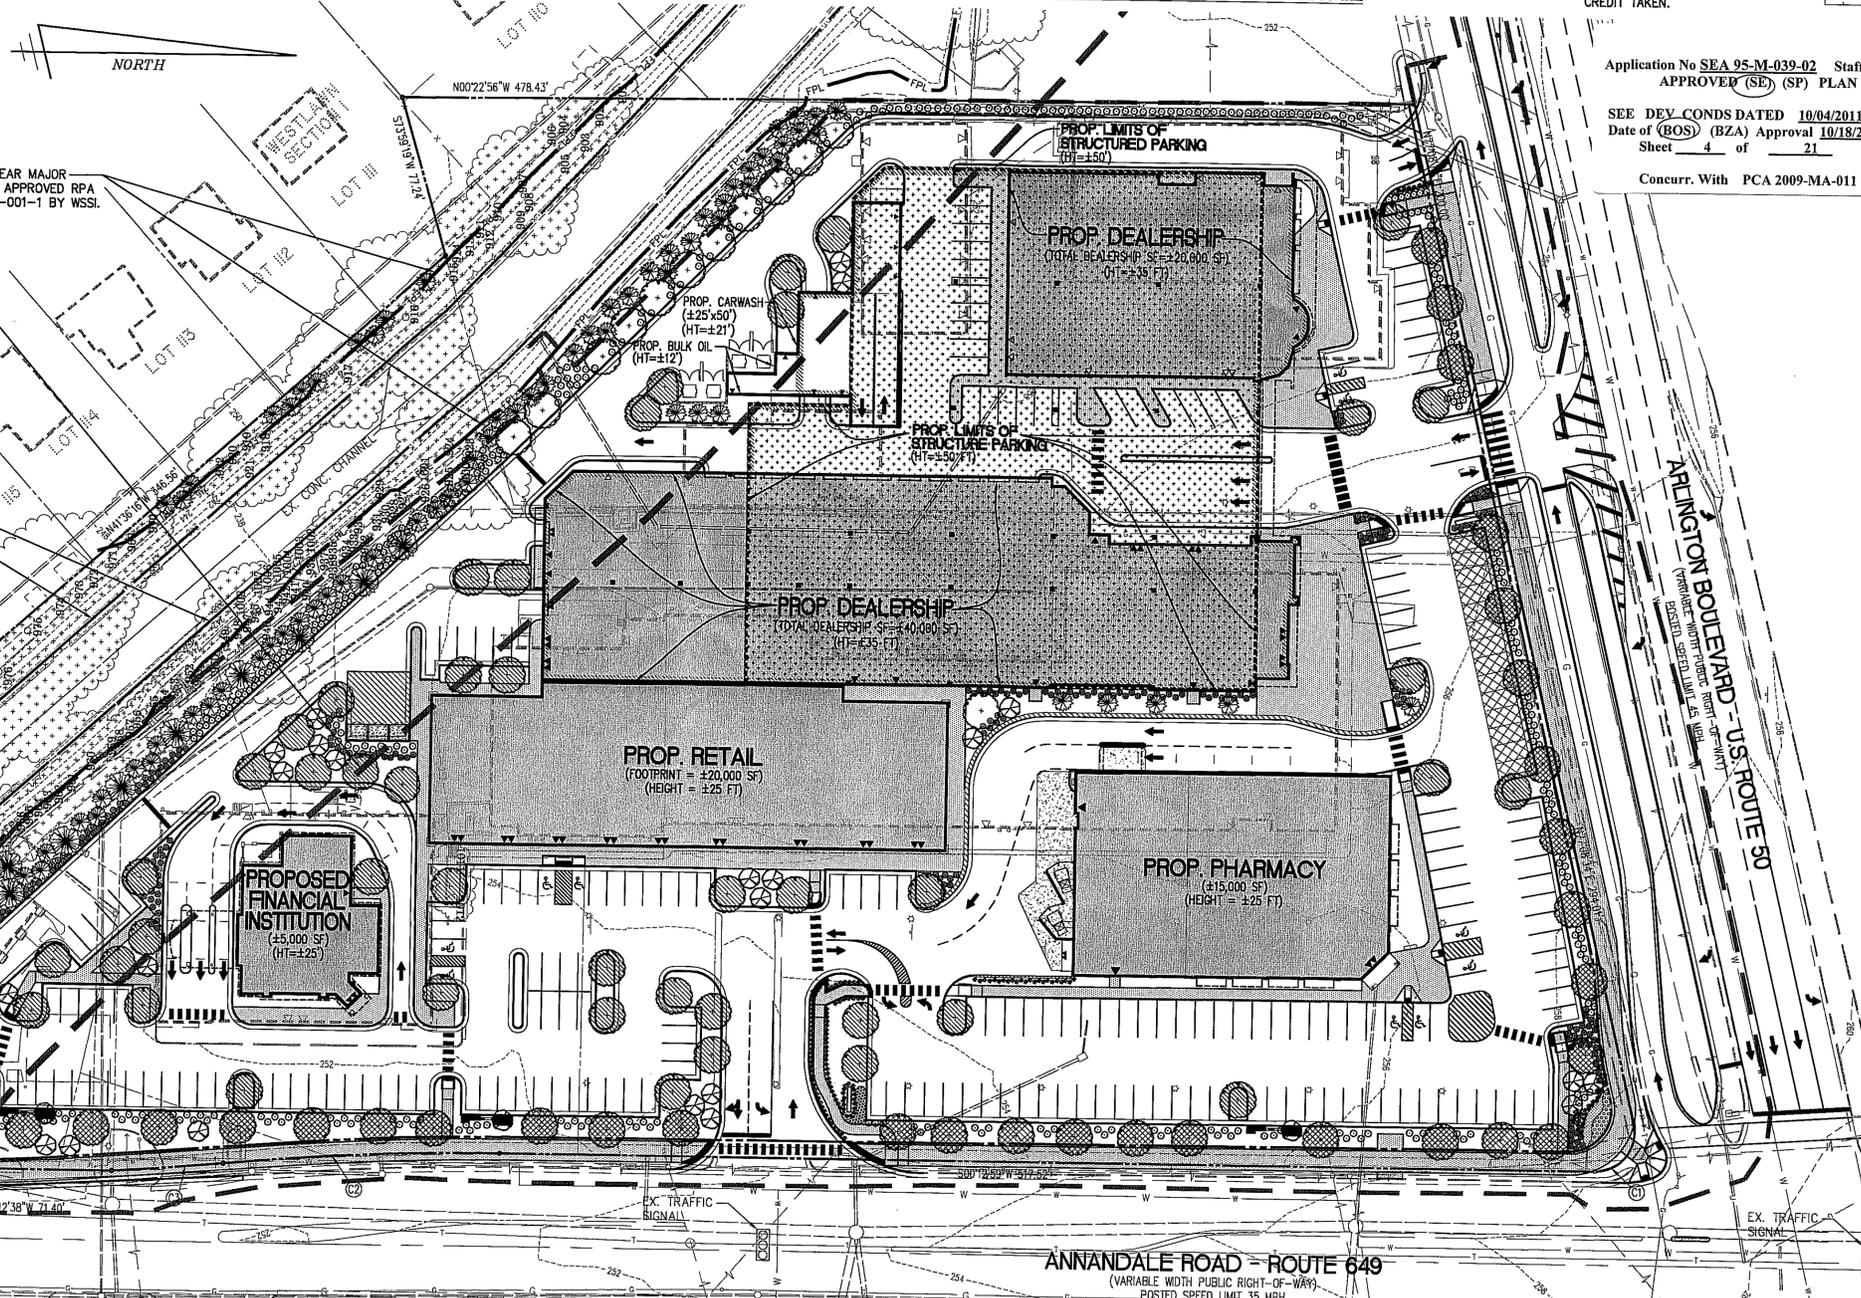


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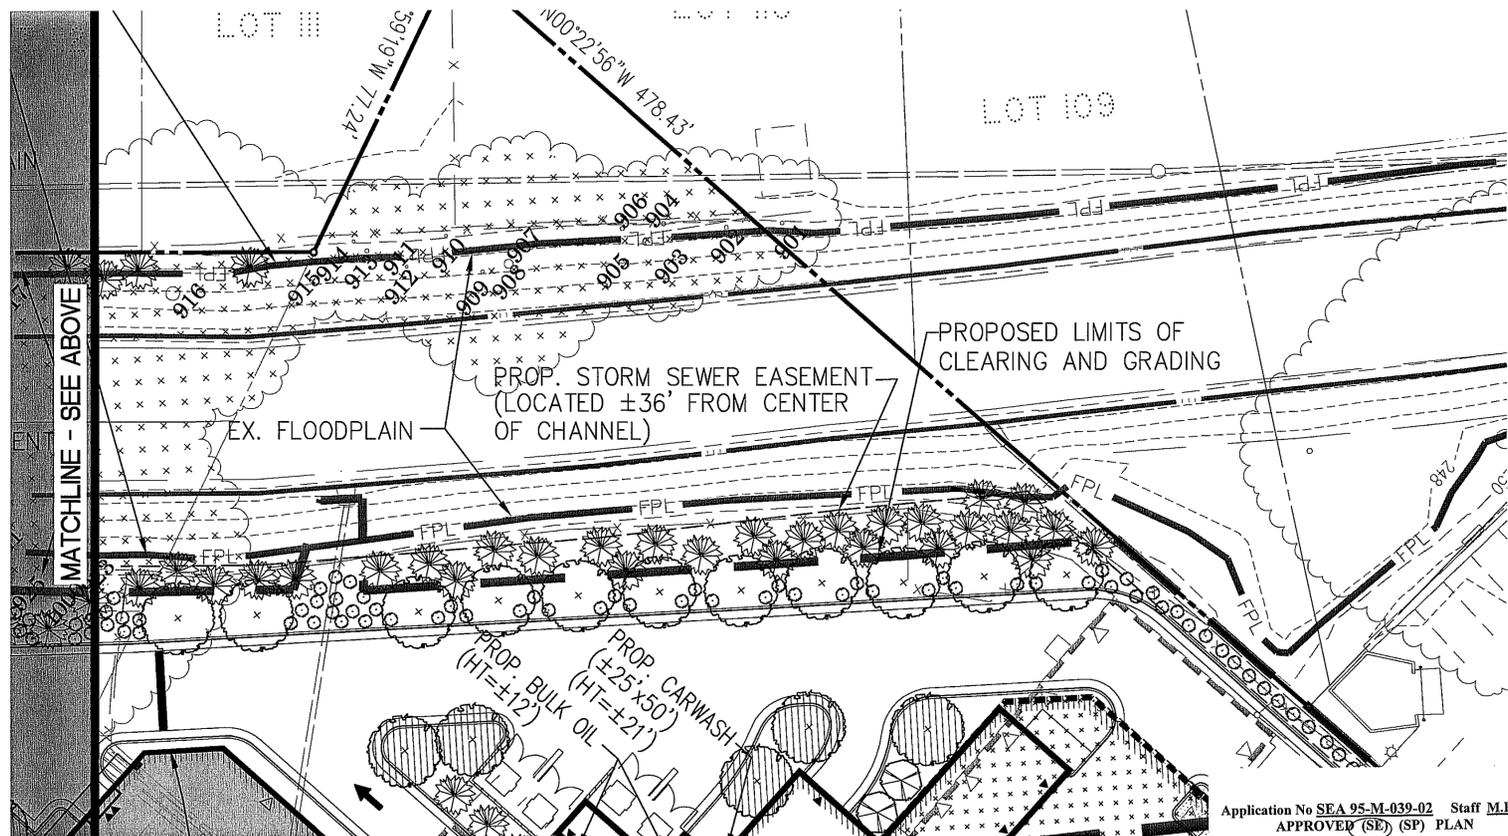
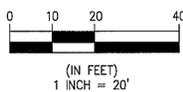
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CONCEPTUAL LANDSCAPE PLAN
BILL PAGE HONDA & WESTLAWN SHOPPING CENTER
MASON DISTRICT
FAIRFAX COUNTY, VIRGINIA

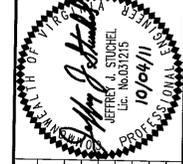

LANDSCAPE LEGEND

- PROPOSED DECIDUOUS TREES (COUNTED TOWARDS INTERIOR PARKING LOT LANDSCAPING)
- PROPOSED DECIDUOUS TREES (COUNTED TOWARDS PERIPHERAL PARKING LOT LANDSCAPING)
- PROPOSED MEDIUM DECIDUOUS/ORNAMENTAL TREES/FILTERRA
- PROPOSED EVERGREEN TREES
- PROPOSED DECORATIVE PLANTINGS
- EXISTING TREE COVER TO REMAIN. TREES WITHIN A STORM SEWER OR SANITARY SEWER EASEMENT HAVE NO CREDIT TAKEN.

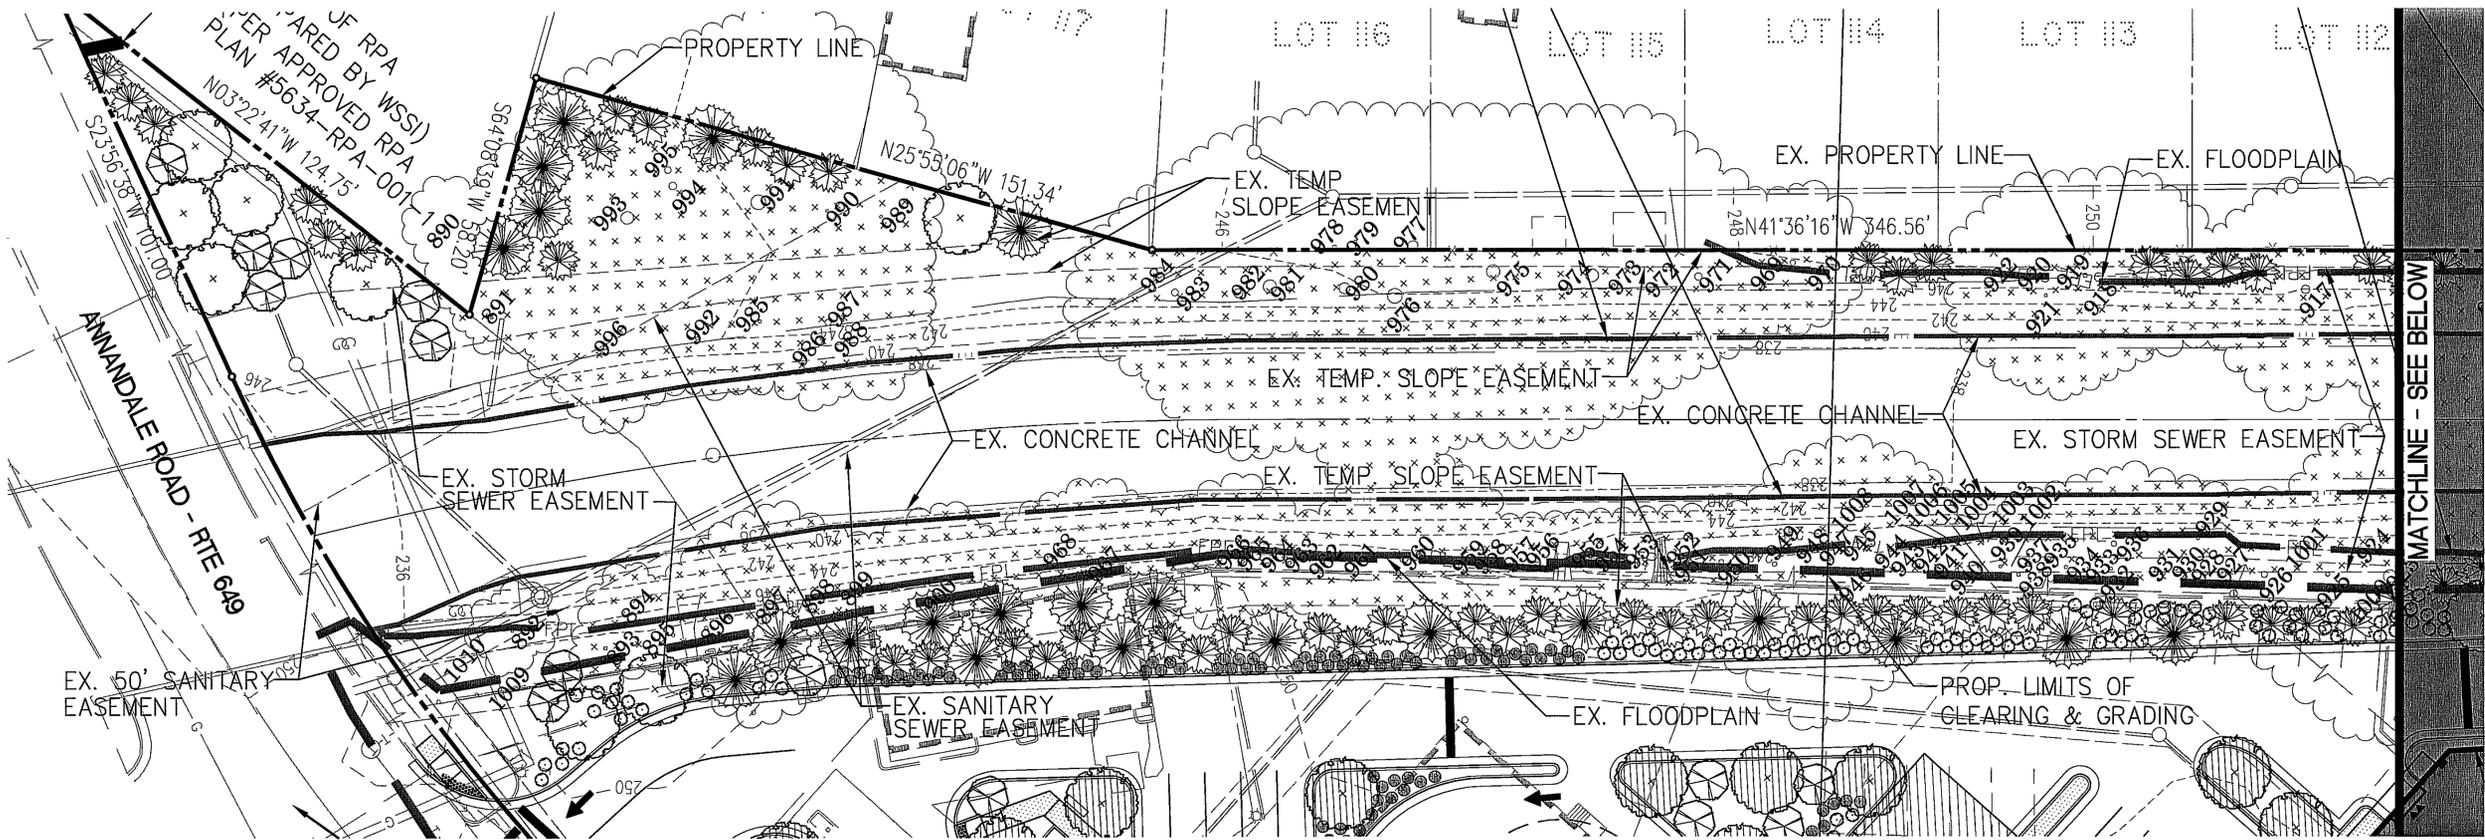

Application No SEA 95-M-039-02 Staff M.B.
 APPROVED (SE) (SP) PLAN

SEE DEV CONDS DATED 10/04/2011
 Date of (BOS) (BZA) Approval 10/18/2011
 Sheet 5 of 21

Concurr. With PCA 2009-MA-011

WALTER L. PHILLIPS
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NO.	DESCRIPTION	DATE	REVISION APPROVED BY	DATE	APPROVED BY

DETAIL OF LANDSCAPING AT TRIPPS RUN
BILL PAGE HONDA & WESTLAWN SHOPPING CENTER
 MASON DISTRICT
FAIRFAX COUNTY, VIRGINIA

TABLE 12.10 - 10-YEAR CANOPY CALCULATION WORKSHEET

Step	Totals	Reference
A. Tree Preservation Target and Statement		
A 1	Place the Tree Preservation Target calculations and statement here preceding the 10-year tree canopy calculations	SEE TABLE 12.3 SHT. 4 see § 12-0508.2 for list of required elements and worksheet
B. Tree Canopy Requirement		
B1	Identify gross site area =	364,252 SF § 12-0511.1A
B2	Subtract area dedicated to parks, road frontage, and	10,910 SF § 12-0511.1B
B3	Subtract area of exemptions = (THIS INCLUDES FLOODPLAIN/STORM EASEMENT AREA)	54,610 SF § 12-0511.1C(1) through § 12-0511.1C(6)
B4	Adjusted gross site area (B1 - B2) =	350,264 SF
B5	Identify site's zoning and/or use	C-6
B6	Percentage of 10-year tree canopy required =	10% § 12-510.1 and Table 12.4
B7	Area of 10-year tree canopy required (B4 x B 5) =	35,026 SF
B8	Modification of 10-year Tree Canopy Requirements requested?	NO Yes or No
B9	If B8 is yes, then list plan sheet where modification request is located	N/A Sheet number
C. Tree Preservation		
C1	Tree Preservation Target Area =	0
C2	Total canopy area meeting standards of § 12-0400 =	0
C3	C2 x 1.25 =	0 § 12-0510.3B
C4	Total canopy area provided by unique or valuable forest or woodland communities =	0
C5	C4 x 1.5 =	0 § 12-0510.3B(1)
C6	Total of canopy area provided by "Heritage," "Memorial," "Specimen," or "Street" trees =	0
C7	C6 x 1.5 to 3.0 =	0 § 12-0510.3B(2)
C8	Canopy area of trees within Resource Protection Areas and 100-year floodplains =	140,726 SF*
C9	C8 x 1.0 =	N/A § 12-0510.3C(1)
C10	Total of C3, C5, C7 and C9 =	NA If area of C10 is less than B7 THEN REMAINDER requirement must be met through tree planting - go to D
D. Tree Planting		
D1	Area of canopy to be met through tree planting (B7-C10) =	34,100 SF
D2	Area of canopy Planted for air quality benefits =	
D3	x 1.5 =	§ 12-0510.4B(1)
D4	Area of canopy planted for energy conservation =	
D5	x 1.5 =	§ 12-0510.4B(2)
D6	Area of canopy planted for water quality benefits =	
D7	x 1.25 =	§ 12-0510.4B(3)
D8	Area of canopy planted for wildlife benefits =	
D9	x 1.5 =	§ 12-0510.4B(4)
D10	Area of canopy provide by native trees =	
D11	x 1.5 =	§ 12-0510.4B(5)
D12	Area of canopy provided by improved cultivars and varieties =	
D13	1.25 =	§ 12-0510.4B(6)
D14	Area of canopy provided through tree seedlings =	§ 12-0510.4D(1)
D15	Area of canopy provided through native shrubs or woody seed mix =	
D16	x1.0 =	§ 12-0510.4D(1)
D17	Percentage of D14 represented by D15 =	Must not exceed 33% of D14
D18	Total of canopy area provided through tree planting =	34,100 SF
D19	Is an offsite planting relief requested?	NO Yes or No
D20	Tree Bank or Tree Fund?	NO § 12-0512
D21	Canopy area requested to be provided through offsite banking or tree fund	0
D22	Amount to be deposited into the Tree Preservation and Planting Fund	0
E. Total of 10-year Tree Canopy Provided		
E1	Total of canopy area provided through tree preservation (C10) =	0
E2	Total of canopy area provided through tree planting (D17) =	34,100 SF
E3	Total of canopy area provided through offsite mechanism (D19) =	0
E4	Total of 10-year Tree Canopy Provided = (E1+E2+E3)	34,100 SF Total of E1 through E3. Area should meet or exceed area REQUIRED BY B7

NATIVE/DESIRABLE TREE COVER, NO ADDITIONAL CREDIT TAKEN
NOTE:

SPECIES OF TREE AND RELATED CATEGORY (SUCH AS DESIRABLE SPECIES, NATIVE, AND WILDLIFE CREDITS) WILL BE DETERMINED AT TIME OF SITE PLAN. PLANT TOTALS LISTED DO NOT INCLUDE ANY ADDITIONAL CREDITS FOR THE CATEGORIES LISTED ABOVE.

URBAN FOREST MANAGEMENT
POLICY ON LANDSCAPE IMPLEMENTATION
November 17, 2010

This compilation of selected portions of the Public Facilities Manual is intended to summarize and clarify regulations pertaining to the implementation of landscape plans on development sites subject to review and inspection by the County. Included are regulations governing the most common areas of noncompliance experienced by staff in the course of conducting landscape inspections, and a brief summary of the policy regarding seasonal landscape deferrals.

Tree Species and Size

1. Trees and shrubs that are planted shall be of the species and size specified on the approved plans. There shall be no deviations from the approved sizes specified except as approved by Fairfax County Urban Forest Management (UFMD), (PFM 12-0705.1A)

2. All trees and shrubs shall meet the standards for sizes and quality specified in the American Association of Nurserymen's American Standard for Nursery Stock, (ANSI Z60.1-1996). See attachment #1. (PFM 12-0705.1B)

Species Substitutions

3. Species substitutions within the tree categories listed in Table 12.17 are generally accepted unless otherwise specified by proffered conditions, development conditions, special exceptions, or special permits. Any tree substitution shall also be in conformance with the following. (PFM 12-0705.1C)

- Plant Diversity** - The use of substitutions shall not result in any species making up more than 10 percent, and shall not result in any one genus making up more than 33 percent, of the total number of trees required to be planted on the site. (PFM 12-0515.1L)
- Authorization** - A letter signed by the permittee shall be provided to UFMD acknowledging any proposed substitutions to trees and shrubs shown on the approved plans. (PFM 12-0705.1C(2))
- Substitutions Outside of Tree Category** - Substitution of a tree shown on the approved plan from one tree category, as listed in PFM Table 12.17, with a tree from a different category shall require a revision to the approved plan. (PFM 12-0705.1C(3))
- Species Suitability** - Substituted species must be suited to the post-development conditions of the planting location for which it is intended. (PFM 12-0601.1E)
- Additional Tree Cover Credit** - In cases where additional tree cover credit has been given, no tree substitutions shall be made except as approved by the Urban Forest Management. Examples of additional credit include the following:
 - Air Quality, PFM 12-0510.4B(1)
 - Water Quality, PFM 12-0510.4B(3)
 - Wildlife Benefits, PFM 12-0510.4B(4)
 - Native Trees, PFM 12-0510.4B(5)

Planting Locations

4. Planting locations of all trees on the site shall be in substantial conformance with the approved plan. UFMD acknowledges that not all trees may be optimally located, as shown on the plan, and encourage input from Permittees and their landscape professionals regarding proposed improvements that might be implemented. Any substantive deviations from the approved plan that are made in the field must be approved by UFMD and shall be in conformance with the following:

- Planting Area** - At least the minimum size planting area shall be provided for each tree according to its projected 10-year tree cover area as found in Table 12.7. (PFM 12-0601.1B)
- Environmental Conditions** - Light, moisture, and other conditions affecting the health and viability of the tree at the field location shall be suitable for the species. (PFM 12-0601.1E)
- Compacted Soil** - If planting in areas that have been previously compacted, the soil shall be properly prepared (tilled and amended as needed based on soil samples) to a depth of 12 inches, prior to installation of landscape material. Soil within individual planting holes shall not be amended. (PFM 12-0705.3B)
- Restrictive Barriers** - Trees shall be planted no closer than four feet from any restrictive barrier. (PFM 12-0510.4E(5))
- Spacing** - Trees shall be spaced so that the outer limit of their projected 10-year tree cover area, as indicated in Table 12.19, does not significantly overlap; or as determined appropriate by UFMD for site conditions and to promote long-term survival. (PFM 12-0510.4E(6))
- Easements** - Trees for tree cover credit shall not be planted within any existing or proposed public utility easement or within five feet of storm drainage easements that contain pipes. In addition, trees shall not be planted in an area that will interfere with existing or proposed utilities or with maintenance of the utility, as determined by the Director of DPWES. (PFM 12-0515.6B)

Staking and Guying

5. Staking and guying should only be implemented where site conditions warrant their use. Planted trees should be assessed individually and staking and guying installed only as required. Conditions where staking and guying may be necessary to ensure stability include: windy locations, steep slopes, or where vandalism may be a concern. All staking and guying material must be removed within one year of plant installation (PFM 12-0705.3C)

Seasonal Landscape Deferrals

6. A Seasonal Landscape Deferral may be granted when seasonal or weather-related conditions, such as excessively wet soil, extended periods of drought, or frozen ground, substantially reduce the survivability of the plant material, as determined by the Urban Forest Management. A request for a landscape deferral will not be granted for landscaping required prior to the issuance of a RUP or Non-RUP when seasonal or weather-related conditions on the site plan do not preclude planting. Lack of species availability may justify the approval of a Seasonal Landscape Deferral when specific plant species are required by proffers or conditions.


7. The party responsible for the placement of the performance bond and conservation deposit for the project shall act as the Applicant for this seasonal deferral. Seasonal Landscape Deferral request forms can be obtained from the Environmental and Facilities Inspections Division or the Urban Forest Management.

8. At the time of final inspection for release of performance bond and conservation deposit, all of the plant material is inspected. Plant material previously inspected, as part of the process to release any deferral deposit that may have existed, is not exempt from this final inspection. All plant material must be healthy and in good condition.

Requirements Prior to Approval of RUP/Non-RUP

9. The landscaping and screening requirements of Article 13 or of any approved proffered condition, special permit, special exception or variance must be completed prior to approval of any Residential or Non-Residential Use Permit, provided, however, that completion of the requirements may be delayed when justification satisfactory to the Director is provided; such justification shall include an agreement and bond with surety satisfactory to the Director for completion in accordance with a firm schedule for timely completion. (ZO 18-704.3) See Seasonal Landscape Deferrals above.

Virginia Cooperative Extension
REPRINTED 2004

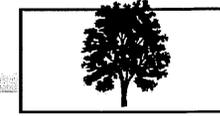

Horticulture
PUBLICATION 430-285

Tree and Shrub Planting Guidelines

Bonnie Lee Appleton and Susan French*

Plant and Site Selection

Select trees and shrubs well-adapted to conditions of individual planting sites. Poorly-sited plants are doomed from the start, no matter how carefully they're planted.

Test soil drainage before planting. Dig a test hole as deep as your planting hole and fill with water. If water drains at a rate of less than one inch per hour, consider installing drainage to carry water away from the planting hole base, or moving or raising the planting site (barn construction).

Also consider using more water-tolerant species. For trees, try red maple, sycamore, bald cypress, willow oak, or river birch. For shrubs, try inkberry, redbud, dogwood and buttonbush. Avoid dogwoods, azaleas, boxwoods, Japanese hollies, and other plants that don't like "wet feet" when drainage is poor.

Examine soil for compaction before planting. If soils are compacted, consider replacement with a good loam soil, or incorporation of several inches of an organic material such as composted yard waste to a depth of at least 8 inches over the entire planting area. Do not incorporate small quantities of sand - compaction will increase and drainage decrease.

Site Preparation

Dig shallow planting holes two to three times as wide as the root ball. Wide, shallow holes encourage horizontal root growth that trees and shrubs naturally produce.

In well-drained soil, dig holes as deep as the root ball. In poorly-drained heavy clay soil, dig holes one to two inches shallower than the root ball. Cover the exposed root ball top with mulch.

Don't dig holes deeper than root balls or put loose soil beneath roots because loose soil will compact over time, leaving trees and shrubs planted too deep. Widen holes near the soil surface where most root growth occurs. Score walls of machine-dug (auger, backhoe) holes to prevent girdling.

Backfill holes with existing unamended soil. Do not incorporate organic matter such as peatmoss into

*Extension Specialist and Extension Technician, respectively. AMDC, Hampton Roads, Virginia Tech



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copper-treatment on the interior container wall. These container modifications and treatments minimize circling roots after planting.

Tree Care After Planting

Remove tags and labels from trees and shrubs to prevent girdling branches and trunks.

Good follow-up watering helps promote root growth. Drip irrigation systems and water reservoir devices can facilitate watering.

Mulch, but don't over mulch newly planted trees and shrubs. Two to three inches of mulch is best - less if a fine material, more if coarse. Use either organic mulches (shredded or chunk pine bark, pine straw, composts) or inorganic mulches (volcanic and river rocks).

Keep mulch from touching tree trunks and shrub stems. This prevents disease and rodent problems if using organic mulches, and bark abrasion if using inorganic mulches.

Don't use black plastic beneath mulch around trees and shrubs because it blocks air and water exchange. For

backfill for individual planting holes. Differences in soil pore sizes will be created causing problems with water movement and root growth between the root ball, planting hole, and surrounding soil.

Backfill half the soil, then water thoroughly to settle out air pockets. Finish backfilling, then water again. Cover any exposed root ball tops with mulch.

Incorporate slow-release granular fertilizers into backfill soil to provide nitrogen, or if a soil test indicates a need for phosphorus or potassium. Avoid using fast-release agronomic fertilizers that can dehydrate tree roots. Use no more than 1/4 actual nitrogen per 1,000 lb. of planting hole surface. (Example - if using 18-6-12 with a 5 diameter hole, incorporate 0.3 oz. per planting hole.)

Tree and Shrub Preparation

Closely inspect the wrapping around root balls of B&B (balled and burlapped) trees and shrubs. Growers use many synthetic materials, as well as burlap treated to retard degradation, to wrap root balls. Many of these materials will not degrade. To insure root growth into surrounding soil, remove pinning nails or rope lacing, then cut away or drop the wrapping material to the bottom of the planting hole, backfilling over it.

Wire baskets used to protect root balls degrade very slowly underground. Remove the top 8-12 inches of wire to keep equipment from getting caught in wire loops, and surface roots from girdling.

Remove all rope, whether jute or nylon, from trunks. Again, degradation is slow or nonexistent, and ropes can girdle trunks and roots.

Remove plastic containers from container-grown trees and shrubs. For plants in fiber pots, break away the top or remove the pot entirely. Many fiber pots are coated to extend their shelf life, but this slows degradation below ground and retards root extension.


If roots are circling around the root ball exterior, cut through the roots in a few places. Cutting helps prevent circling roots from eventually girdling the trunk. Select trees grown in containers with vertical ribs or a

added weed control, use landscape fabrics that resist weed root penetration. Apply only one to two inches of mulch atop fabrics to prevent weeds from growing in the mulch.

Only stake trees with large crowns, or those situated on windy sites or where people may push them over. Stake for a maximum of one year. Allow trees a slight amount of flex rather than holding them rigidly in place. Use guying or attaching material that won't damage the bark. To prevent trunk girdling, remove all guying material after one year.

Most trees should not have their trunks wrapped. Wrapping often increases insect, disease, and water damage to trunks. Thin-barked trees planted in spring or summer into hot or paved areas may benefit from wrapping if a white wrap is used. To avoid trunk girdling, do not attach wraps with wire, nylon rope, plastic ties, or electrical tape. If wraps must be used, remove within one year.

For protection against animal or equipment damage, install guards to protect the trunk. Be sure the guards are loose-fitting and permit air circulation.

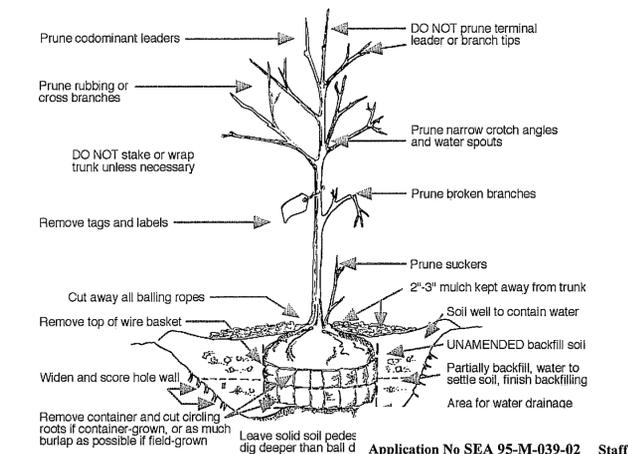

Application No SEA 95-M-039-02 Staff M.B.
APPROVED (SE) (SP) PLAN

SEE DEV. CONDS DATED 10/04/2011
Date of (BOS) (BZA) Approval 10/18/2011
Sheet 7 of 21

Concurr. With PCA 2009-MA-011

CONCEPTUAL LANDSCAPE NOTES AND DETAILS

BILL PAGE HONDA &
WESTLAWN SHOPPING CENTER
MASON DISTRICT
FAIRFAX COUNTY, VIRGINIA

WALTER L. PHILLIPS
INCORPORATED
ESTABLISHED 1945
DATE: 5/17/11; REV: 7/28/2011; 8/20/11; 10/4/11
SCALE: AS NOTED



NO.	DESCRIPTION	DATE	APPROVED BY

Engineers • Surveyors • Planners
Landscape Architects • Arborists
207 PARK AVENUE
FALLS CHURCH, VIRGINIA 22046
(703) 532-6163 Fax (703) 533-1301
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NOTE:
ALL NOTES AND DETAILS PROVIDED ON THIS SHEET ARE CURRENT AT TIME OF PLAN PREPARATION. CONTRACTOR IS RESPONSIBLE FOR USING CURRENT DETAILS AT TIME OF CONSTRUCTION.

PRELIMINARY BMP FACILITY DESIGN CALCULATIONS

PART 1: LIST ALL OF THE SUBAREAS AND "C" FACTORS USED IN THE BMP COMPUTATIONS

SUBAREA DESIGNATION AND DESCRIPTION (1)	"C" (2)	ACRES (3)
A ₁ ONSITE DRAINAGE AREA TO FILTERRA #1	0.75	0.16
A ₂ ONSITE DRAINAGE AREA TO FILTERRA #2	0.78	0.39
A ₃ ONSITE DRAINAGE AREA TO FILTERRA #3	0.76	0.30
A ₄ ONSITE UNCONTROLLED	0.78	7.51
TOTAL SITE AREA		8.36 AC.

PART 2: COMPUTE THE WEIGHTED AVERAGE "C" FACTOR FOR THE SITE

(A) AREA OF THE SITE (a) **8.36 ACRES**

(B) WEIGHTED AVERAGE "C" FACTOR = 0.76

(SEE OVERALL SITE DRAINAGE SUMMARY, THIS SHEET)

PART 3: COMPUTE THE TOTAL PHOSPHORUS REMOVAL FOR THE SITE

SUBAREA DESIGNATION (1)	BMP TYPE (2)	REMOVAL EFF. (%) (3)	AREA RATIO (4)	"C" FACTOR RATIO (5)	PRODUCT (6)
A ₁ ONSITE DRAINAGE AREA TO FILTERRA #1		40	0.16/8.36	0.75/0.76	0.76%
A ₂ ONSITE DRAINAGE AREA TO FILTERRA #2		40	0.39/8.36	0.78/0.76	1.92%
A ₃ ONSITE DRAINAGE AREA TO FILTERRA #3		40	0.30/8.36	0.76/0.76	1.44%
(a) TOTAL =					4.12%

PART 4: DETERMINE COMPLIANCE WITH PHOSPHORUS REMOVAL REQUIREMENT

(A) SELECT REQUIREMENT (a) **-2.38%**

- * WATER SUPPLY OVERLAY DISTRICT (OCCOQUAN WATERSHED) = 50 %
- * CHESAPEAKE BAY PRESERVATION AREA (NEW DEVELOPMENT) = 40 %
- * CHESAPEAKE BAY PRESERVATION AREA (REDEVELOPMENT) = $[1 - 0.9 \times ((\text{"PRE"/"POST"}) \times 100) = [1 - 0.9 \times (0.91/0.77)] \times 100 = -6.36\%$


(B) IF LINE 3(a) **4.12** > LINE 4(a) **-6.36** THEN PHOSPHORUS REMOVAL REQUIREMENT IS SATISFIED.

NOTE

THIS SUMMARY IS PRELIMINARY AND SUBJECT TO CHANGE AT TIME OF SITE PLAN.

BMP NARRATIVE

THE PROPOSED CONSTRUCTION IS CONSIDERED REDEVELOPMENT DUE TO THE FACT THAT THERE IS NO NET INCREASE IN IMPERVIOUS AREA IN A RPA AND LESS THAN A 20% INCREASE IN IMPERVIOUS AREA IN A RMA. THE C-FACTOR DECREASES FROM 0.85 PRE-DEVELOPMENT TO 0.76 POST-DEVELOPMENT. THEREFORE, THE PHOSPHOROUS REMOVAL REQUIREMENT FOR THIS REDEVELOPMENT IS -6.36% WHICH MEANS THERE IS NO BMP REQUIREMENT. HOWEVER, BMP FACILITIES ARE CURRENTLY PROPOSED ON THIS PLAN. THREE FILTERRA TREE BOX FILTERS ARE CURRENTLY PROPOSED FOR A TOTAL PHOSPHOROUS REMOVAL OF 4.12% AS SHOWN IN THE ABOVE COMPUTATIONS. IN ADDITION TO USING FILTERRAS, WE WILL BE UTILIZING CISTERNS FOR LANDSCAPE IRRIGATION. AT TIME OF SITE PLAN, OTHER BMP FACILITIES, SUCH AS PERMEABLE PAVERS, MAY BE PROPOSED TO HELP THE QUALITY OF THE WATER LEAVING THIS SITE.

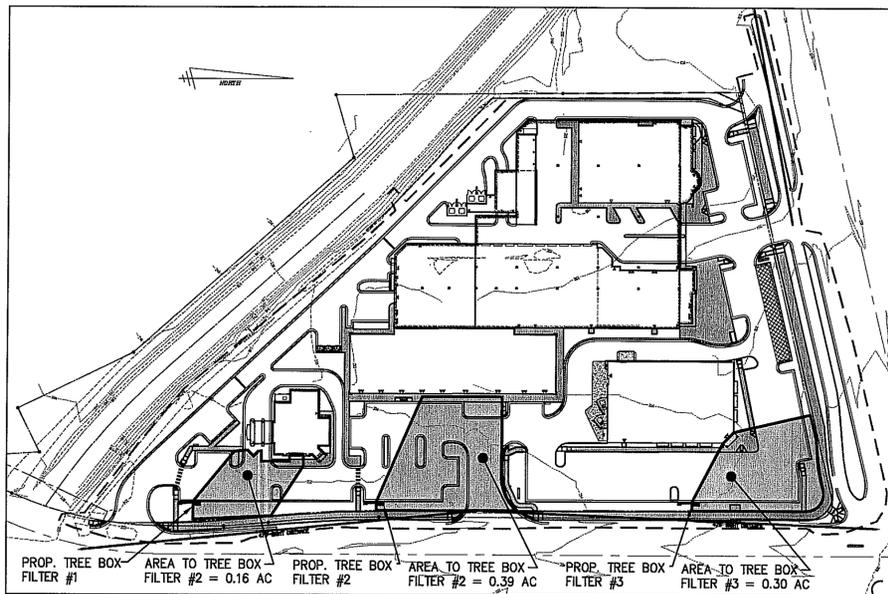

BMP FACILITY MAP

SCALE: 1"=100'

PRELIMINARY OVERALL SITE DRAINAGE SUMMARY

I. PRE-DEVELOPMENT:

- A. TOTAL AREA = 8.36 AC.
CONTRIBUTING AREAS:
7.62 AC. @ 0.90 (IMPERVIOUS AREA ON-SITE)
0.74 AC. @ 0.30 (GREEN AREA ON-SITE)
8.36 AC.
- B. WEIGHTED "C":
 $(7.62)(0.90) + (0.74)(0.3) = 0.85$
8.36
- C. TIME OF CONCENTRATION = 5 MIN.
- D. RUNOFF: Q₂ = (0.85)(5.45)(8.36) = 38.73 CFS
Q₁₀ = (0.85)(7.27)(8.36) = 51.66 CFS

II. POST-DEVELOPMENT:

- A. CONTRIBUTING AREAS:
6.41 AC. @ 0.90 (IMPERVIOUS AREA ONSITE)
1.95 AC. @ 0.30 (GREEN AREA ONSITE)
8.36 AC.
- B. WEIGHTED "C":
 $(6.41)(0.90) + (1.95)(0.30) = 0.76$
8.36
- C. RUNOFF: Q₂ = (0.76)(5.45)(8.36) = 34.63 CFS
Q₁₀ = (0.76)(7.27)(8.36) = 46.19 CFS

III. INCREASE:

- Q₂ = 34.63 - 38.73 = -4.10 CFS
- Q₁₀ = 46.19 - 51.66 = -5.47 CFS

NOTE

THIS SUMMARY IS PRELIMINARY AND SUBJECT TO CHANGE AT TIME OF SITE PLAN.

SWM NARRATIVE


THE ALLOWABLE RELEASE FROM THE SITE WITH THE PROPOSED REDEVELOPMENT SHALL BE THE RELEASE FROM THE SITE IN ITS CURRENT DEVELOPED CONDITION. THE 2-YEAR ALLOWABLE RELEASE IS 38.73 CFS AND THE 10-YEAR ALLOWABLE RELEASE IS 51.66 CFS. NO STORMWATER DETENTION IS REQUIRED FOR THIS REDEVELOPMENT AS THE REDEVELOPED SITE HAS A LOWER C-FACTOR AND RUNOFF RATE THAN CURRENTLY EXISTS.

OUTFALL NARRATIVE

THIS SITE IS LOCATED IN THE CAMERON RUN WATERSHED. SITE RUNOFF DRAINS VIA SHEET FLOW, PAVED DITCHES AND STORM SEWER PIPES TO TRIPPS RUN WHICH FLOWS THROUGH THE SITE. WITHIN THE LIMITS OF THE SITE, THE TRIPPS RUN CHANNEL IS IMPROVED WITH CONCRETE AND GROUDED RIP RAP LININGS (SEE TYPICAL SECTION, THIS SHEET). THE EXTENT OF REVIEW FOR ADEQUATE OUTFALL FOR THIS SITE IS LOCATED AT THE POINT WHERE THE CHANNEL LEAVES THE SITE. ALL SITE RUNOFF HAS DRAINED INTO THE CHANNEL BY THIS POINT AND THE TRIPPS RUN DRAINAGE AREA OF 2,185 ACRES EXCEEDS ONE HUNDRED TIMES THE SITE AREA OF 8.36 ACRES.

IT IS IN THE OPINION OF THE SUBMITTING ENGINEER THAT THIS SITE MEETS FAIRFAX COUNTY PFM REQUIREMENTS FOR ADEQUATE OUTFALL. THE EXISTING TRIPPS RUN CHANNEL WAS ANALYZED FOR THE 2-YEAR STORM AND THE FLOW VELOCITIES WERE NOT EROSIIVE WITH THE EXISTING CONCRETE AND GROUDED RIP RAP CHANNEL LINING. THE CAPACITY OF THE CHANNEL IS SUFFICIENT TO CONTAIN THE 10-YEAR STORM WITHIN THE CHANNEL'S BED AND BANKS.

DRAINAGE DIVIDES AND CHANNEL INFORMATION WERE DETERMINED USING AVAILABLE RECORD INFORMATION AND TOPOGRAPHY AS WELL AS INFORMATION GATHERED IN THE FIELD. THIS OUTFALL ANALYSIS IS SUBJECT TO CHANGE WITH FINAL ENGINEERING AND WILL BE REEVALUATED AND VERIFIED AT SITE PLAN.

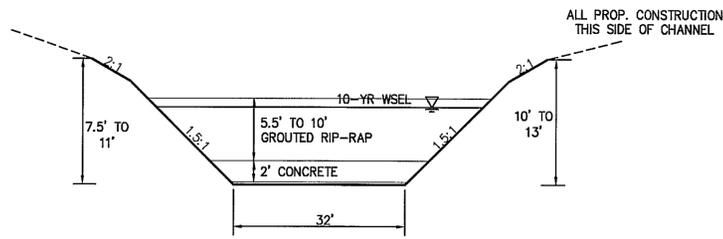

EXISTING IMPROVED CHANNEL SECTION


(TYPICAL) NTS

Tripps Run Channel Flow for a 2 Year Frequency Storm:

Input Data	
Slope	0.005500 ft/ft
Discharge	5,720.00 cfs
Results	
Mannings Coefficient	0.024
Water Surface Elevation	8.55 ft
Elevation Range	0.00 to 11.00
Flow Area	372.8 ft ²
Wetted Perimeter	81.92 ft
Top Width	56.89 ft
Actual Depth	8.55 ft
Critical Elevation	8.82 ft
Critical Slope	0.004890 ft/ft
Velocity	15.34 ft/s
Velocity Head	3.66 ft
Specific Energy	12.21 ft
Froude Number	1.06
Flow Type	Supercritical

Tripps Run Channel Flow for a 10 Year Frequency Storm:

Input Data	
Slope	0.005500 ft/ft
Discharge	2,860.00 cfs
Results	
Mannings Coefficient	0.019
Water Surface Elevation	5.13 ft
Elevation Range	0.00 to 10.00
Flow Area	195.8 ft ²
Wetted Perimeter	49.59 ft
Top Width	46.63 ft
Actual Depth	5.13 ft
Critical Elevation	5.88 ft
Critical Slope	0.003369 ft/ft
Velocity	14.61 ft/s
Velocity Head	3.32 ft
Specific Energy	8.44 ft
Froude Number	1.26
Flow Type	Supercritical

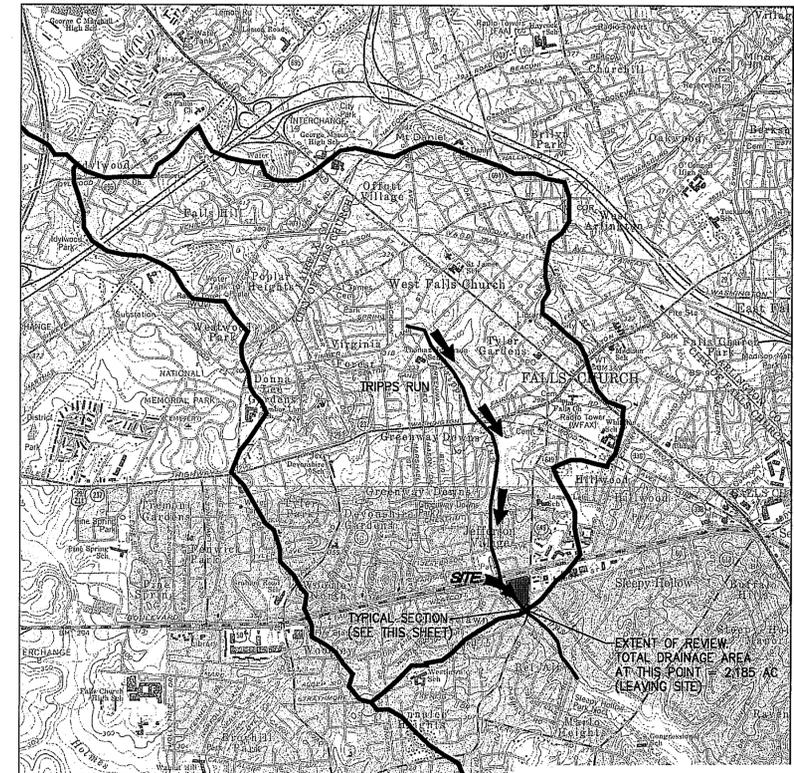

OUTFALL DRAINAGE AREA MAP

SCALE 1"=2000'

Application No **SEA 95-M-039-02** Staff **M.B.**
APPROVED (SB) (SP) PLAN

SEE DEV. CONDS DATED **10/04/2011**
 Date of (BOS) (BZA) Approval **10/18/2011**
 Sheet **8** of **21**

Concurr. With **PCA 2009-MA-011**

STORMWATER MANAGEMENT CHECKLIST

MINIMUM STORMWATER INFORMATION FOR REZONING, SPECIAL EXCEPTION, SPECIAL PERMIT AND DEVELOPMENT PLAN APPLICATIONS

The following information is required to be shown or provided in all zoning applications, or a waiver request of the submission requirement with justification shall be attached. Note: Waivers will be acted upon separately. Failure to adequately address the required submission information may result in a delay in processing this application.

This information is required under the following Zoning Ordinance paragraphs:
 Special Permits (9-011 2J & 2L) Special Exceptions (9-011 2J & 2L)
 Cluster Subdivision (9-615 1G & 1N) Commercial Revitalization Districts (9-622 2A (12) & (14))
 Development Plans PRC District (16-302 3 & 4L) PRC Plan (16-303 1E & 1O)
 FDP P Districts (except PRC) (16-502 1F & 1Q) Amendments (16-202 10F & 10I)

- 1. Plat is at a minimum scale of 1"=50' (unless it is depicted on one sheet with a minimum scale of 1"=100').
- 2. A graphic depicting the stormwater management facility(ies) and limits of clearing and grading accommodate the stormwater management facility(ies), storm drainage pipe systems and outlet protection, pond spillways, access roads, site outfalls, energy dissipation devices, and stream stabilization measures as shown on Sheet **3**.
- 3. Provide:



Facility Name/Type & No.	On-site area served (acres)	Off-site area served (acres)	Drainage area (acres)	Footprint area (sf)	Storage Volume (cf)	If pond, dam height (ft)
N/A						
Totals						
- 4. Onsite drainage channels, outfalls and pipe systems are shown on Sheet **3**.
Pond inlet and outlet pipe systems are shown on Sheet **N/A**.
- 5. Maintenance access (road) to stormwater management facility(ies) are shown on Sheet **N/A**.
Type of maintenance access road surface noted on the plat is **N/A** (asphalt, geotext, gravel, etc.).
- 6. Landscaping and tree preservation shown in and near the stormwater management facility is shown on Sheet **N/A**.
- 7. A 'stormwater management narrative' which contains a description of how detention and best management practices requirements will be met is provided on Sheet **8**.
- 8. A description of the existing conditions of each numbered site outfall extended downstream from the site to a point which is at least 100 times the site area or which has a drainage area of at least one square mile (640 acres) is provided on Sheet **8**.
- 9. A description of how the outfall requirements, including contributing drainage areas of the Public Facilities Manual will be satisfied is provided on Sheet **8**.
- 10. Existing topography with maximum contour intervals of two (2) feet and a note as to whether it is an air survey or field run is provided on Sheets **1, 2, 3**.
- 11. A submission waiver is requested for **N/A**.
- 12. Stormwater management is not required because **REDEVELOPED IMPERVIOUS AREA IS LESS THAN EXISTING.**

THE PROPOSED REDEVELOPMENT WILL NOT INCREASE THE IMPERVIOUS RUNOFF FROM THIS PROPERTY. THEREFORE, NO ADDITIONAL DETENTION WILL BE REQUIRED.

PRELIMINARY STORMWATER MANAGEMENT / BEST MANAGEMENT PRACTICES / OUTFALL ANALYSIS

BILL PAGE HONDA & WESTLAWN SHOPPING CENTER
 MASON DISTRICT
 FAIRFAX COUNTY, VIRGINIA

WALTER L. PHILLIPS
 ENGINEERS • SURVEYORS • PLANNERS
 LANDSCAPE ARCHITECTS • ARBORISTS
 207 PARK AVENUE
 FALLS CHURCH, VIRGINIA 22046
 (703) 532-6163 Fax (703) 533-1301
 www.WLPINC.com
 LICENSED PROFESSIONAL ENGINEER
 LICENSE NO. 1003215
 DATE: 01/11/11; REV. 7/28/2011; 8/18/2011; 8/20/11; 10/4/11
 CHECKED: JUS
 DRAWN: MARW

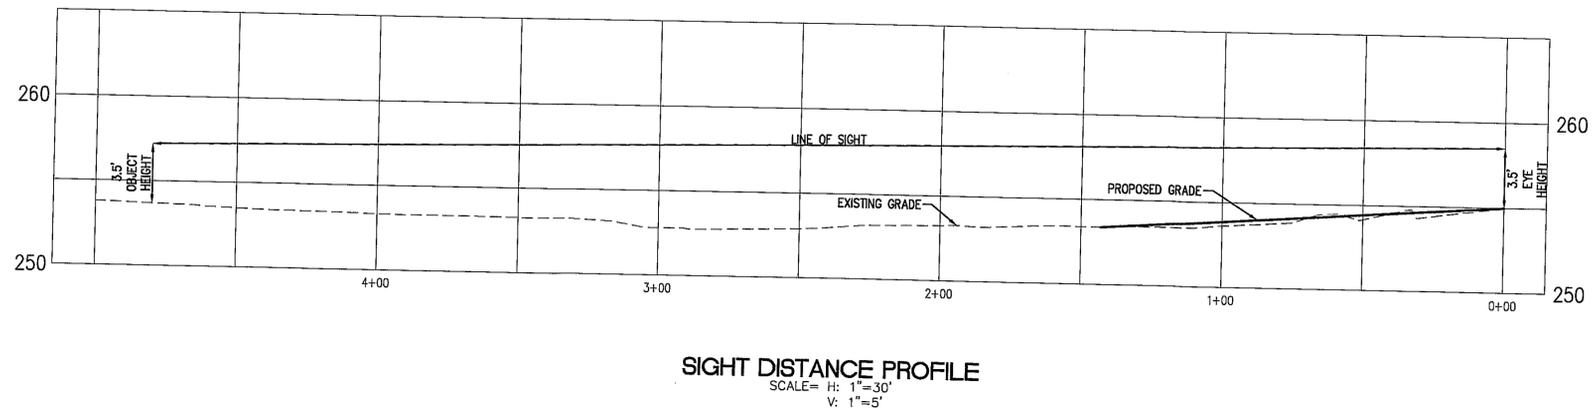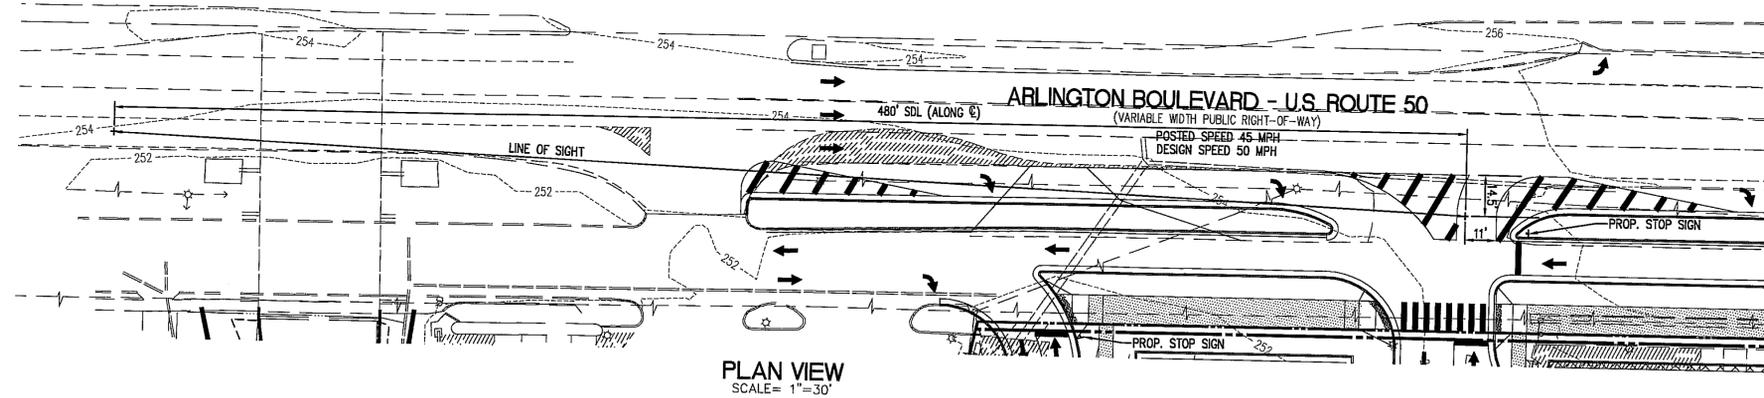

PRELIMINARY SIGHT DISTANCE PROFILES



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WESTLAWN SHOPPING CENTER**
MASON DISTRICT
FAIRFAX COUNTY, VIRGINIA

WALTER L. PHILLIPS
INCORPORATED
ENGINEERS • SURVEYORS • PLANNERS
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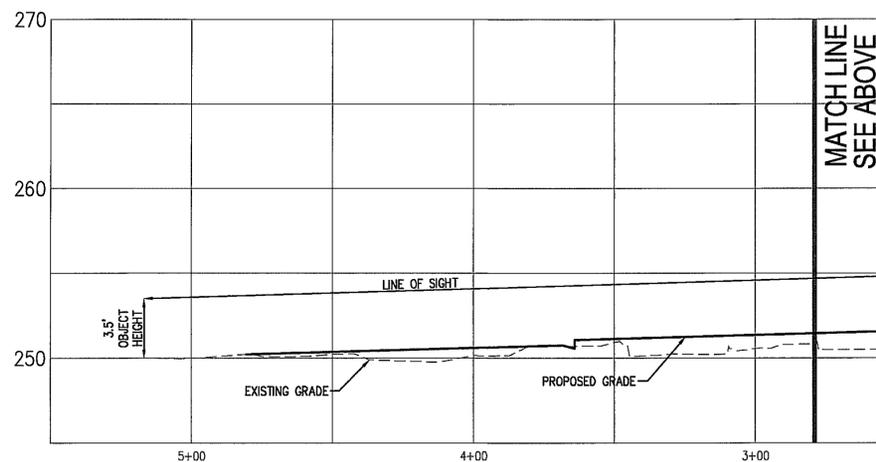
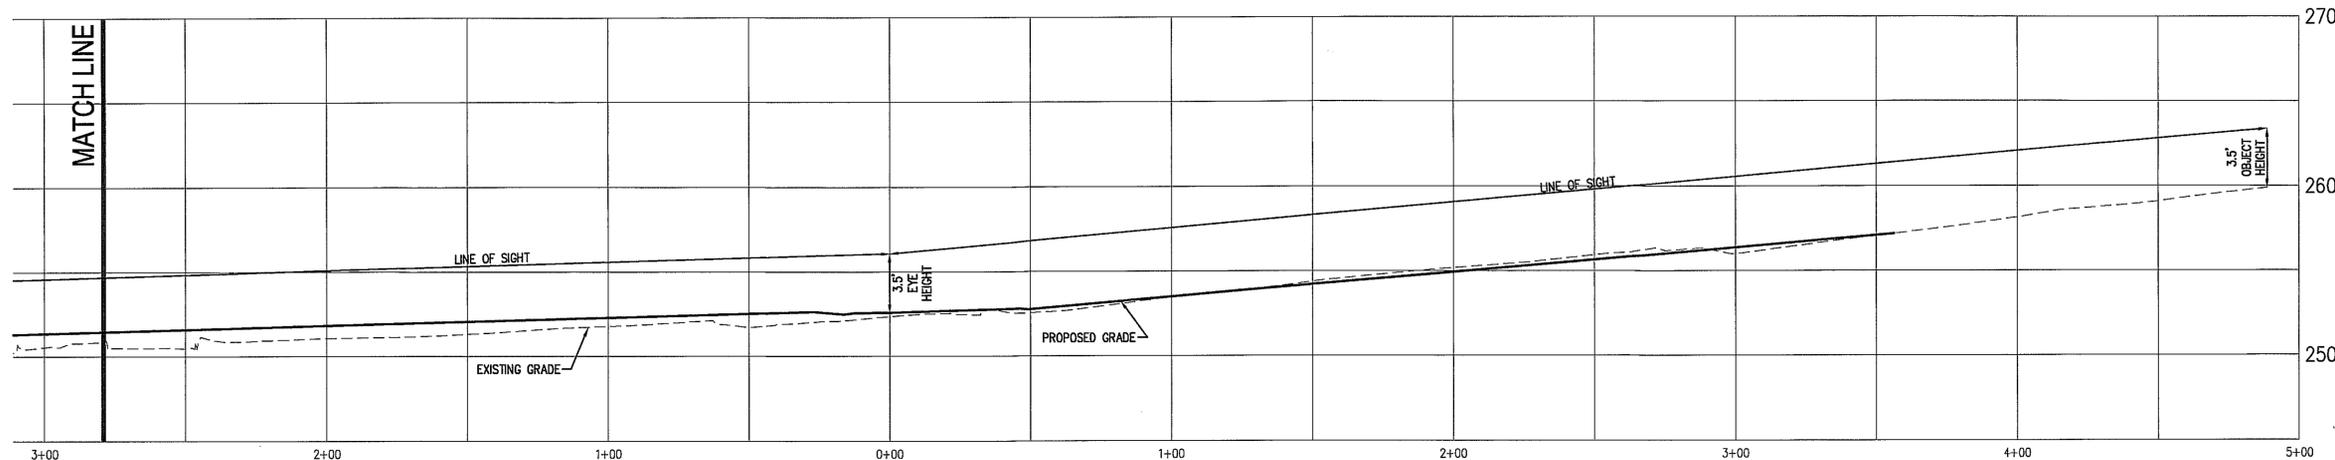


NO.	DESCRIPTION	REVISION APPROVED BY		DATE
		REV. BY	APPROVED	

Application No SEA 95-M-039-02 Staff M.B.
APPROVED (SE) (SP) PLAN
SEE DEV. CONDS DATED 10/04/2011
Date of (BOS) (BZA) Approval 10/18/2011
Sheet 9 of 21
Concurr. With PCA 2009-MA-011

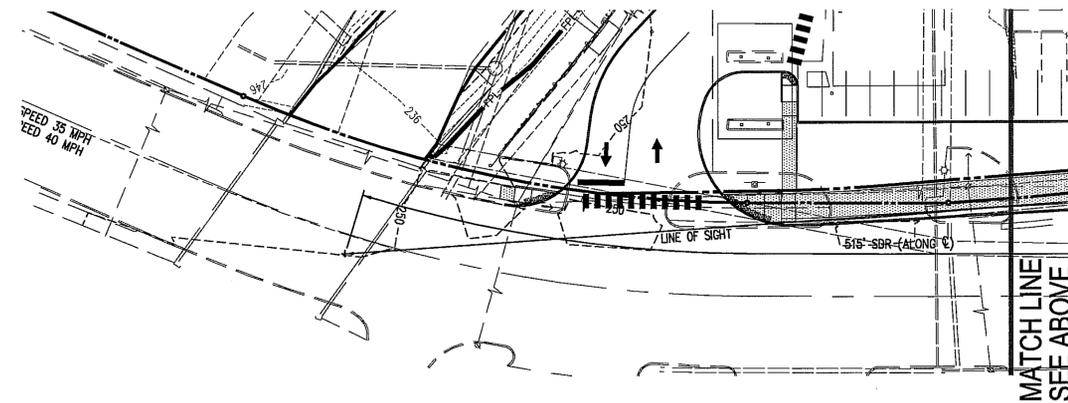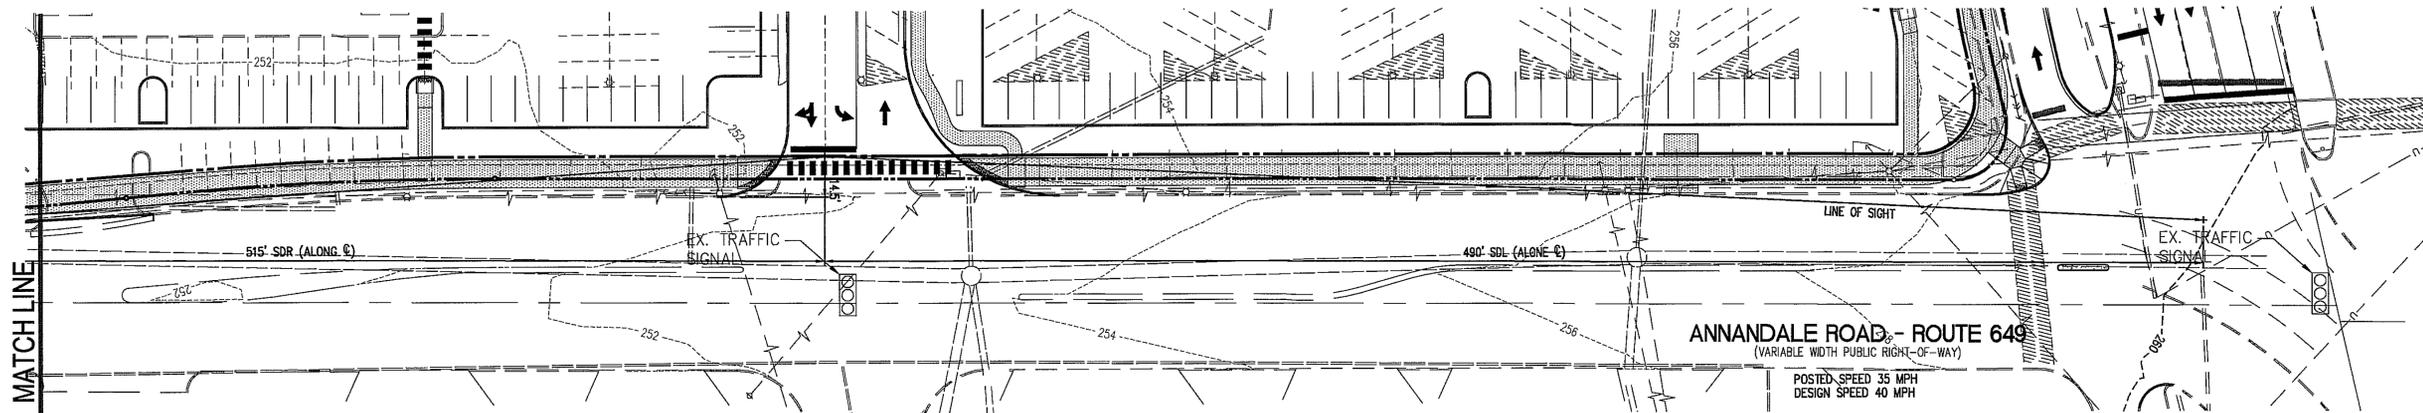

PLAN VIEW
SCALE= 1"=30'



SIGHT DISTANCE PROFILE
SCALE= H: 1"=30'
V: 1"=5'

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WALTER L. PHILLIPS
L I N E C O R P O R A T E D
ESTABLISHED 1945
DATE: 5/11/11; REV. 7/28/2011; 8/20/11; 04/11
DRAWN: MRW
CHECKED: JS

NO.	DESCRIPTION	DATE	REV. BY	APPROVED	DATE


PRELIMINARY SIGHT DISTANCE PROFILES

BILL PAGE HONDA & WESTLAWN SHOPPING CENTER
MASON DISTRICT
FAIRFAX COUNTY, VIRGINIA


Application No SEA 95-M-039-02 Staff M.B.
APPROVED (SE) (SP) PLAN

SEE DEV CONDS DATED 10/04/2011
Date of (BOS) (BZA) Approval 10/18/2011
Sheet 10 of 21

Concurr. With PCA 2009-MA-011

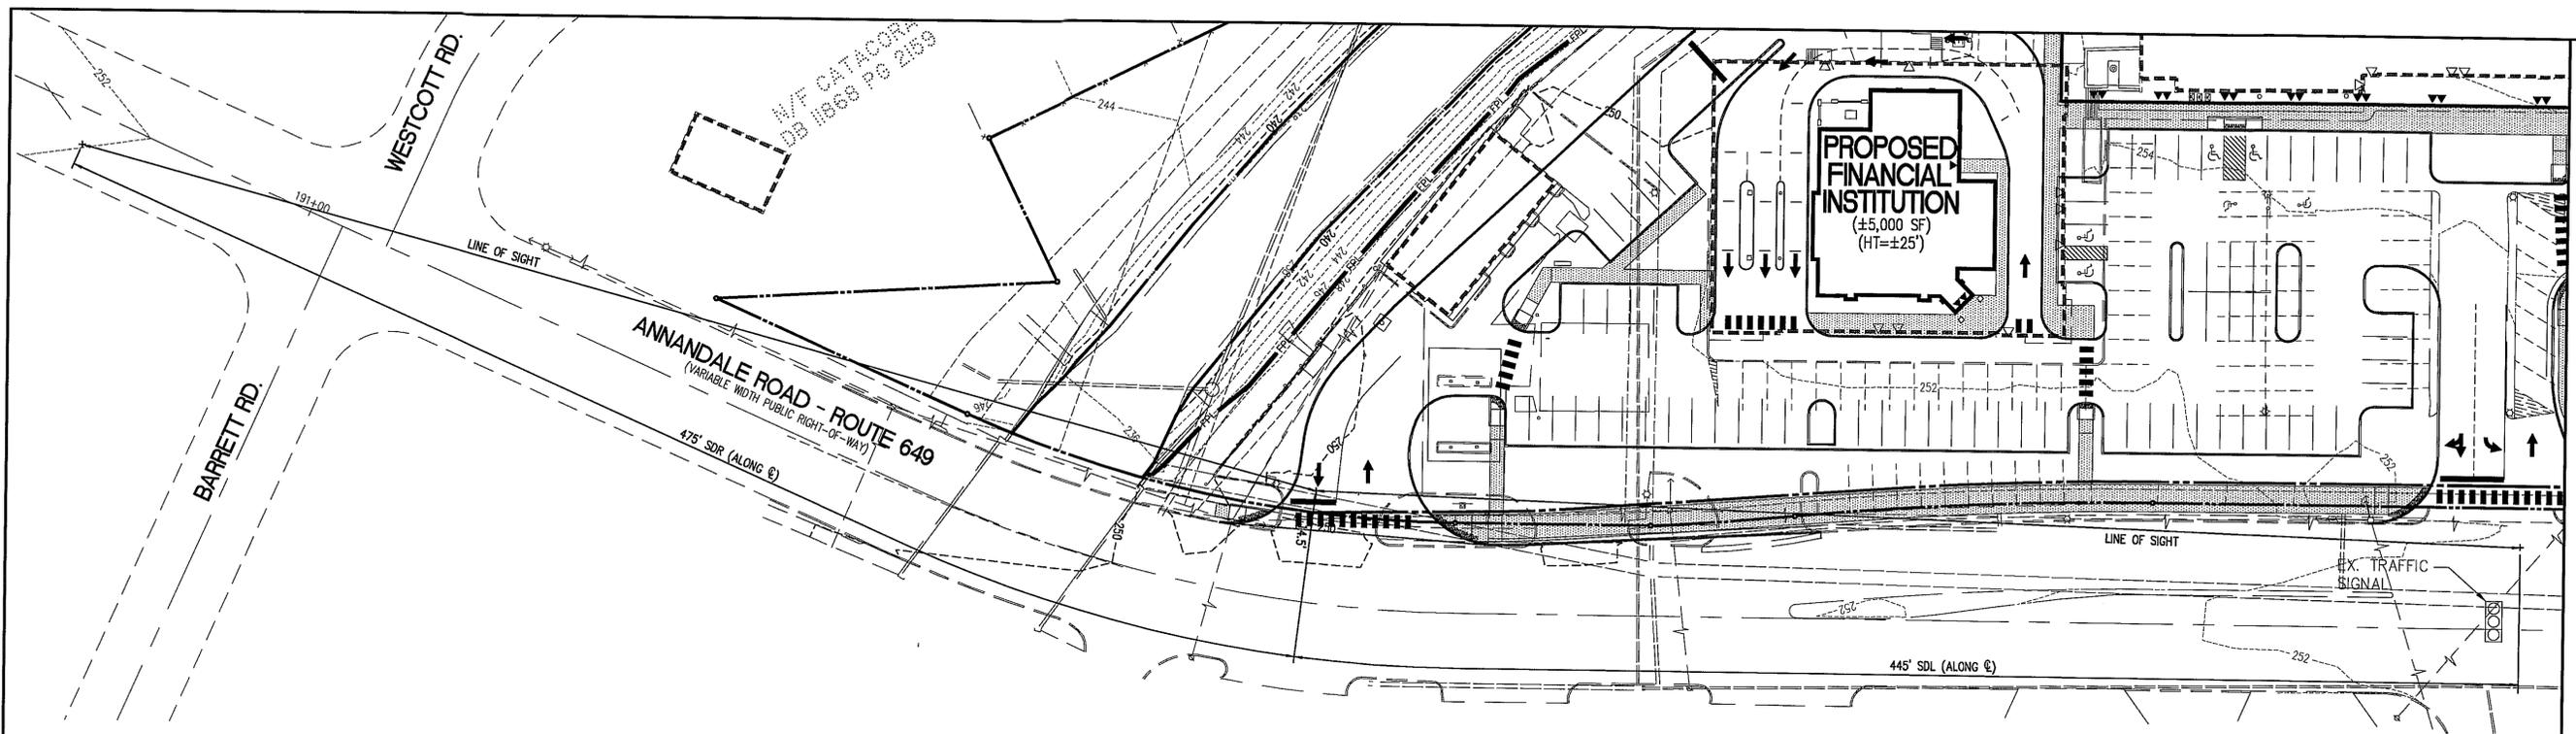

PLAN VIEW
SCALE= 1"=30'

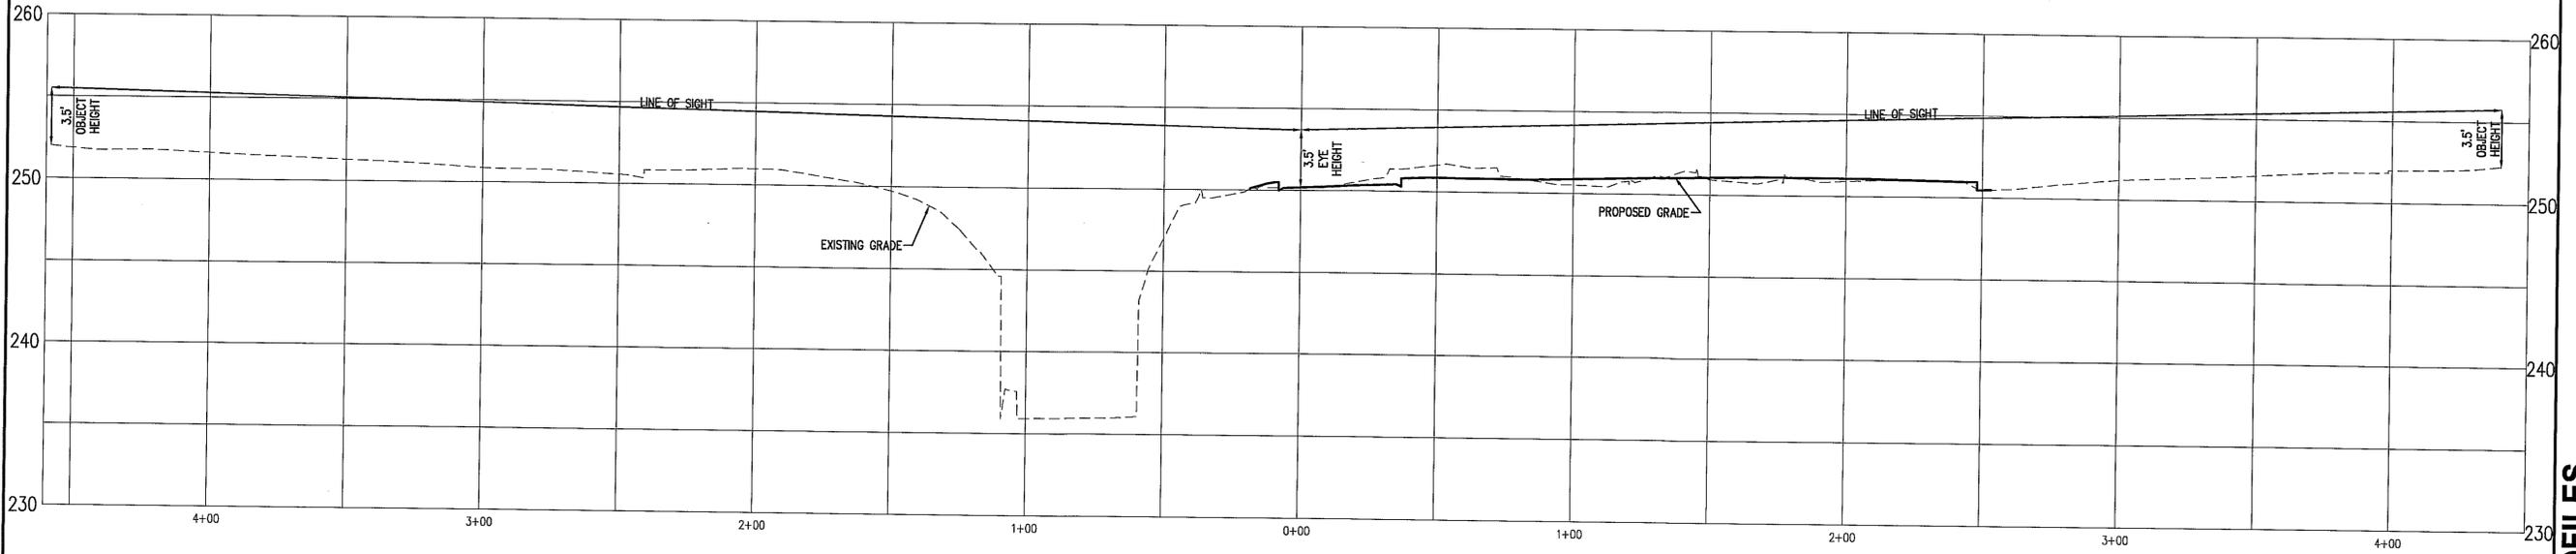

SIGHT DISTANCE PROFILE
SCALE= H: 1"=30'
V: 1"=5'

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INCORPORATED
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(703) 532-6163 Fax (703) 533-1301
www.WLPINC.com
ESTABLISHED 1935
DATE: 8/11/11; REV: 7/28/2011; 8/18/2011; 10/4/11
DRAWN: JARVY
CHECKED: J.S.




NO.	DESCRIPTION	DATE	APPROVED BY	DATE

PRELIMINARY SIGHT DISTANCE PROFILES

BILL PAGE HONDA & WESTLAWN SHOPPING CENTER
MASON DISTRICT
FAIRFAX COUNTY, VIRGINIA



Application No SEA 95-M-039-02 Staff M.B.
APPROVED (SE) (SP) PLAN
SEE DEV CONDS DATED 10/04/2011
Date of (BOS) (BZA) Approval 10/18/2011
Sheet 11 of 21
Concurr. With PCA 2009-MA-011

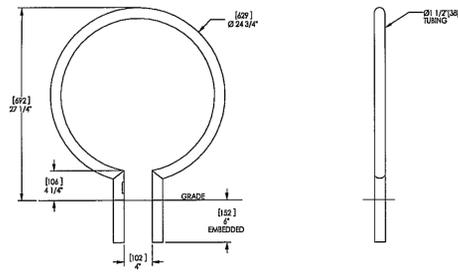

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 KALAMAZOO, MI 49008 FAX: 269-381-3455
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DESIGN GROUP: RND
 DESCRIPTION: BIKE RACK, EMBEDDED
 FABRIC: POLYETHYLENE
 FILE: 91084P
 DRAWN BY: THJ
 CHECKED BY: THJ
 DIMENSIONS ARE IN INCHES (1/16")



BIKE RACK DETAIL

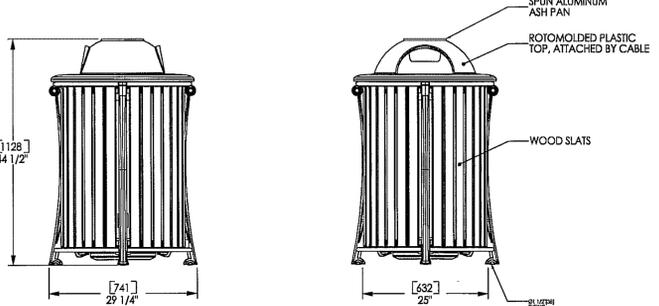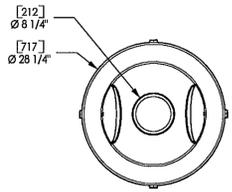

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DESIGN GROUP: RND
 DESCRIPTION: TRASH CAN, EMBEDDED
 FABRIC: POLYETHYLENE
 FILE: 91084P
 DRAWN BY: THJ
 CHECKED BY: THJ
 DIMENSIONS ARE IN INCHES (1/16")

TRASH CAN DETAIL

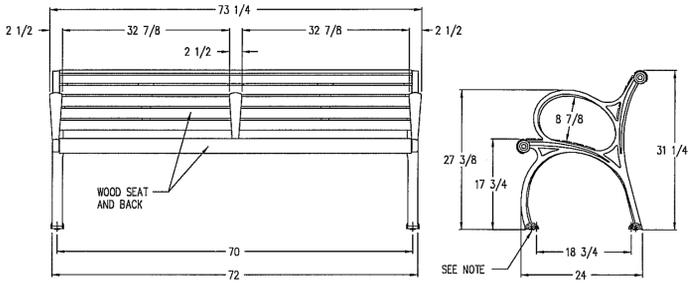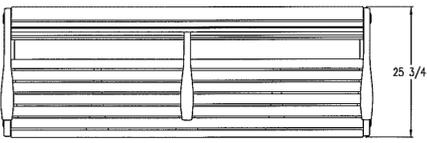


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 KALAMAZOO, MI 49008 FAX: 269-381-3455
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DESIGN GROUP: RND
 DESCRIPTION: BENCH, EMBEDDED
 FABRIC: POLYETHYLENE
 FILE: 91084P
 DRAWN BY: THJ
 CHECKED BY: THJ
 DIMENSIONS ARE IN INCHES (1/16")

TITLE: PLANNELL BENCH - 72" WOOD SEAT PANEL WITH CENTER ROW REST - FREESTANDING OR SURFACE MOUNT
 DESIGN: PLANNELL
 PATENT: D-493,341
 FILE: PL271-04
 DATE: 12-06-00
 AUTHOR: THJ

BENCH DETAIL

SITE DETAILS FOR ILLUSTRATIVE PURPOSES ONLY.

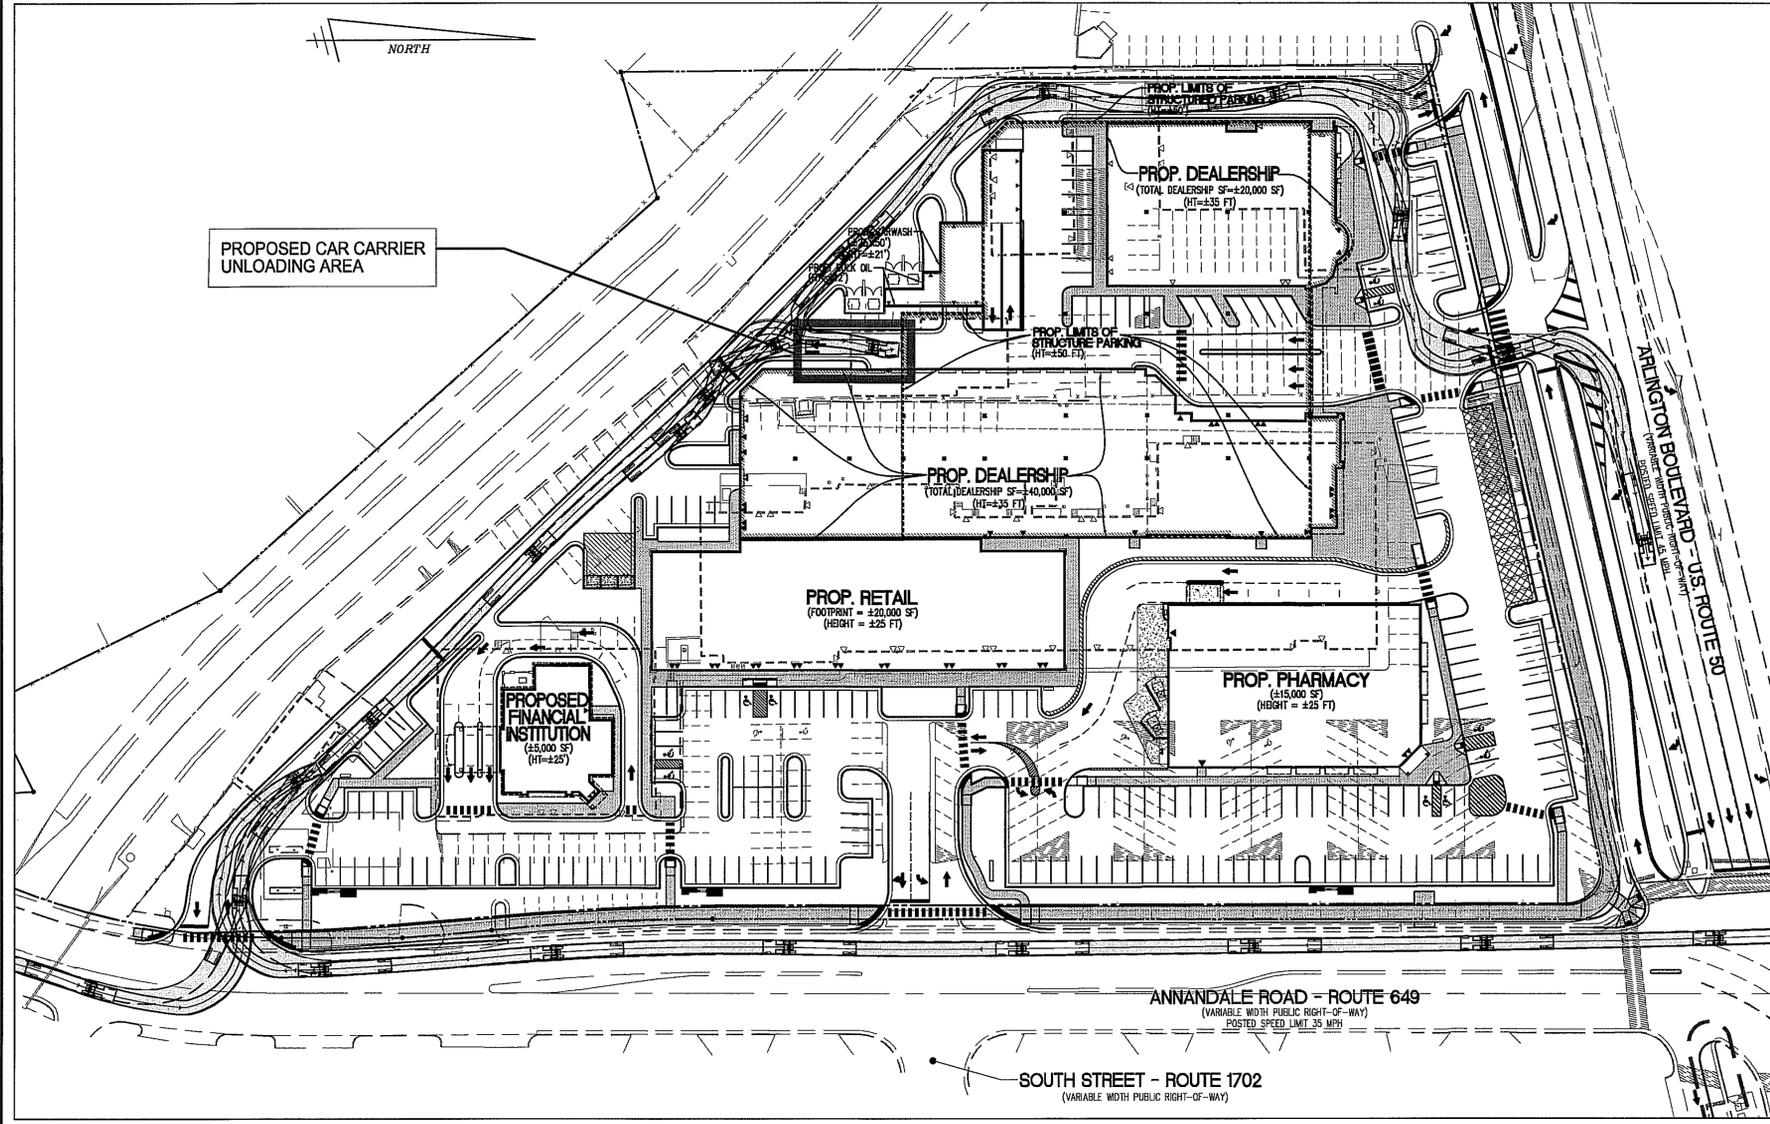

DELIVERY TRUCK CIRCULATION DETAIL
 (NOT TO SCALE)

TRUCK PATH AND SITE DETAILS


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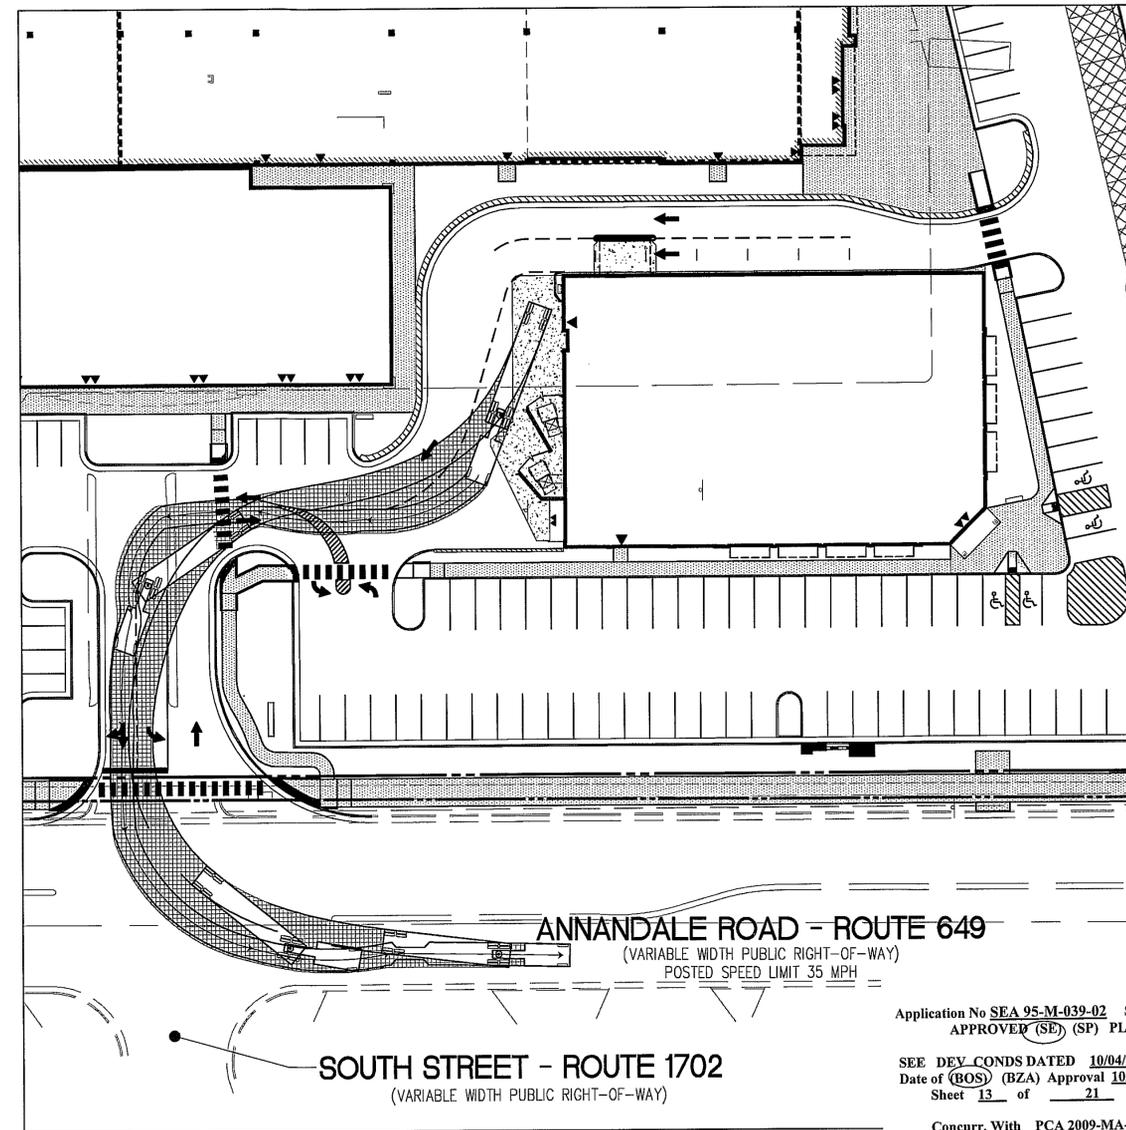


NO.	DESCRIPTION	DATE	REV. BY	APPROVED	DATE


Application No SEA 95-M-039-02 Staff M.B.
 APPROVED (SE), (SP) PLAN
 SEE DEV CONDS DATED 10/04/2011
 Date of (BOS) (BZA) Approval 10/18/2011
 Sheet 12 of 21
 Concurr. With PCA 2009-MA-011




WB-65 TRUCK CIRCULATION DETAIL
ANNANDALE ROAD LOCATION - ENTERING
(NOT TO SCALE)

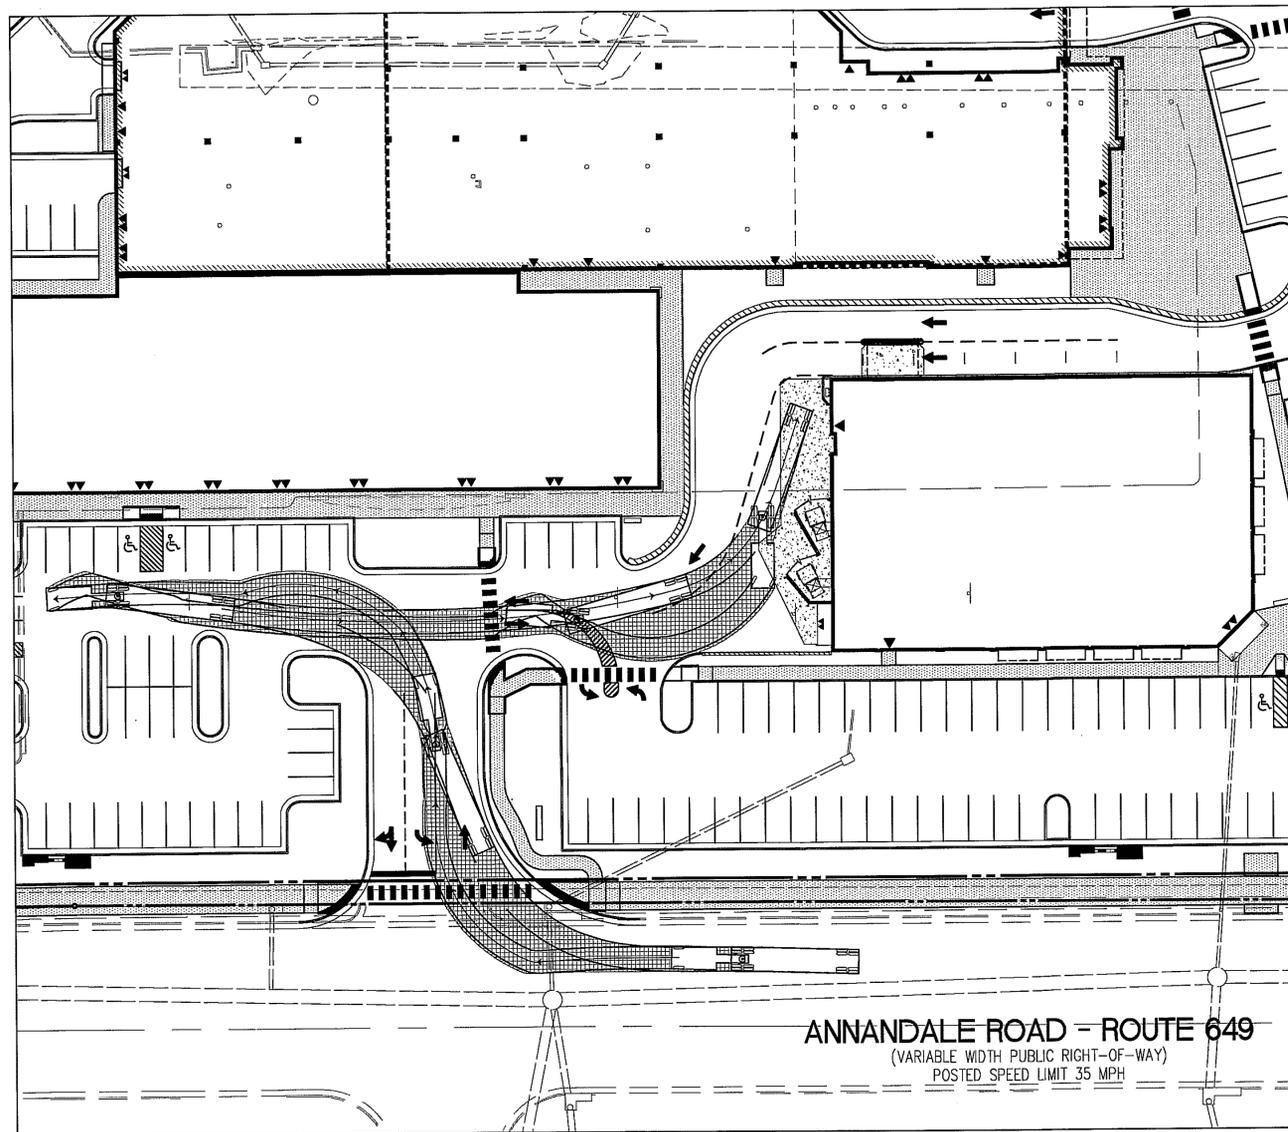


WB-65 TRUCK CIRCULATION DETAIL ANNANDALE ROAD LOCATION - EXITING
AND GARBAGE TRUCK CIRCULATION DETAIL AT PHARMACY
(NOT TO SCALE)

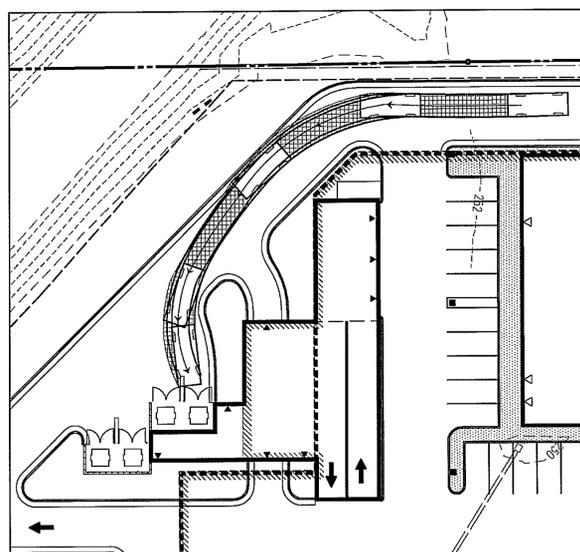


GARBAGE TRUCK CIRCULATION DETAIL
SOUTH WESTERN LOCATION - ENTERING
(NOT TO SCALE)

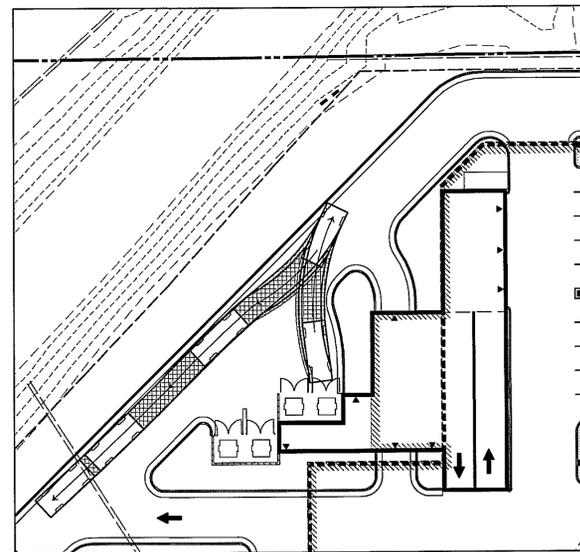

GARBAGE TRUCK CIRCULATION DETAIL
SOUTH WESTERN LOCATION - EXITING
(NOT TO SCALE)

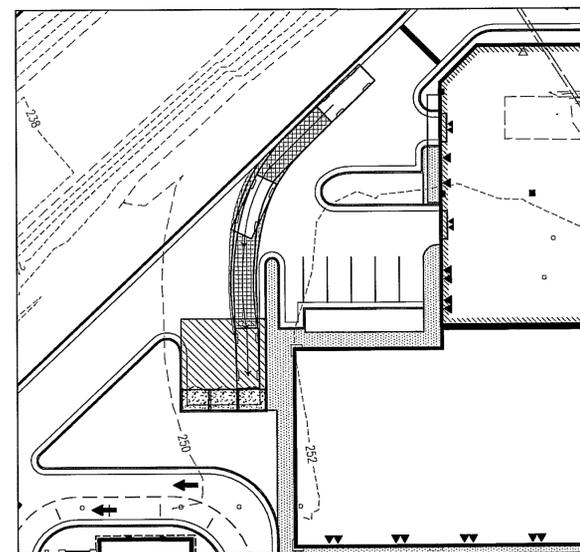

GARBAGE TRUCK CIRCULATION DETAIL
SOUTH EASTERN LOCATION - ENTERING
(NOT TO SCALE)

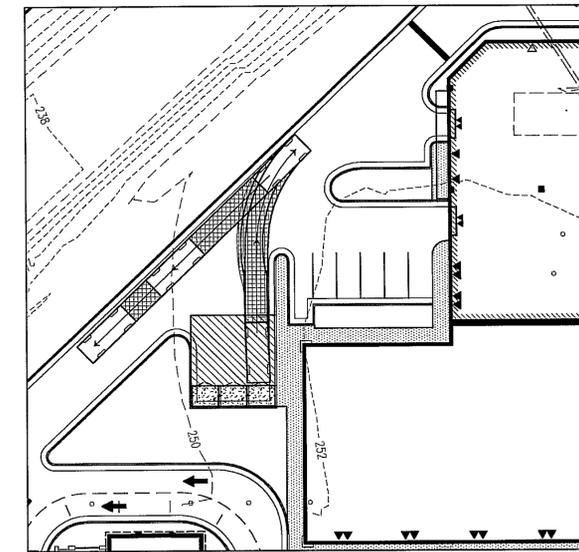

GARBAGE TRUCK CIRCULATION DETAIL
SOUTH EASTERN LOCATION - EXITING
(NOT TO SCALE)


WALTER L. PHILLIPS
INCORPORATED
ESTABLISHED 1945
DATE: 9/11/11; REV: 7/28/2011; 8/18/2011; 8/30/11; 10/4/11
DRAWN: MRYW
CHECKED: JS



NO.	DESCRIPTION	DATE	REV. BY	APPROVED	DATE


TRUCK PATH DETAILS
BILL PAGE HONDA &
WESTLAWN SHOPPING CENTER
MASON DISTRICT
FAIRFAX COUNTY, VIRGINIA

ARLINGTON BOULEVARD - US ROUTE 50
(VARIABLE WIDTH RIGHT OF WAY)
POSTED SPEED LIMIT 45 MPH

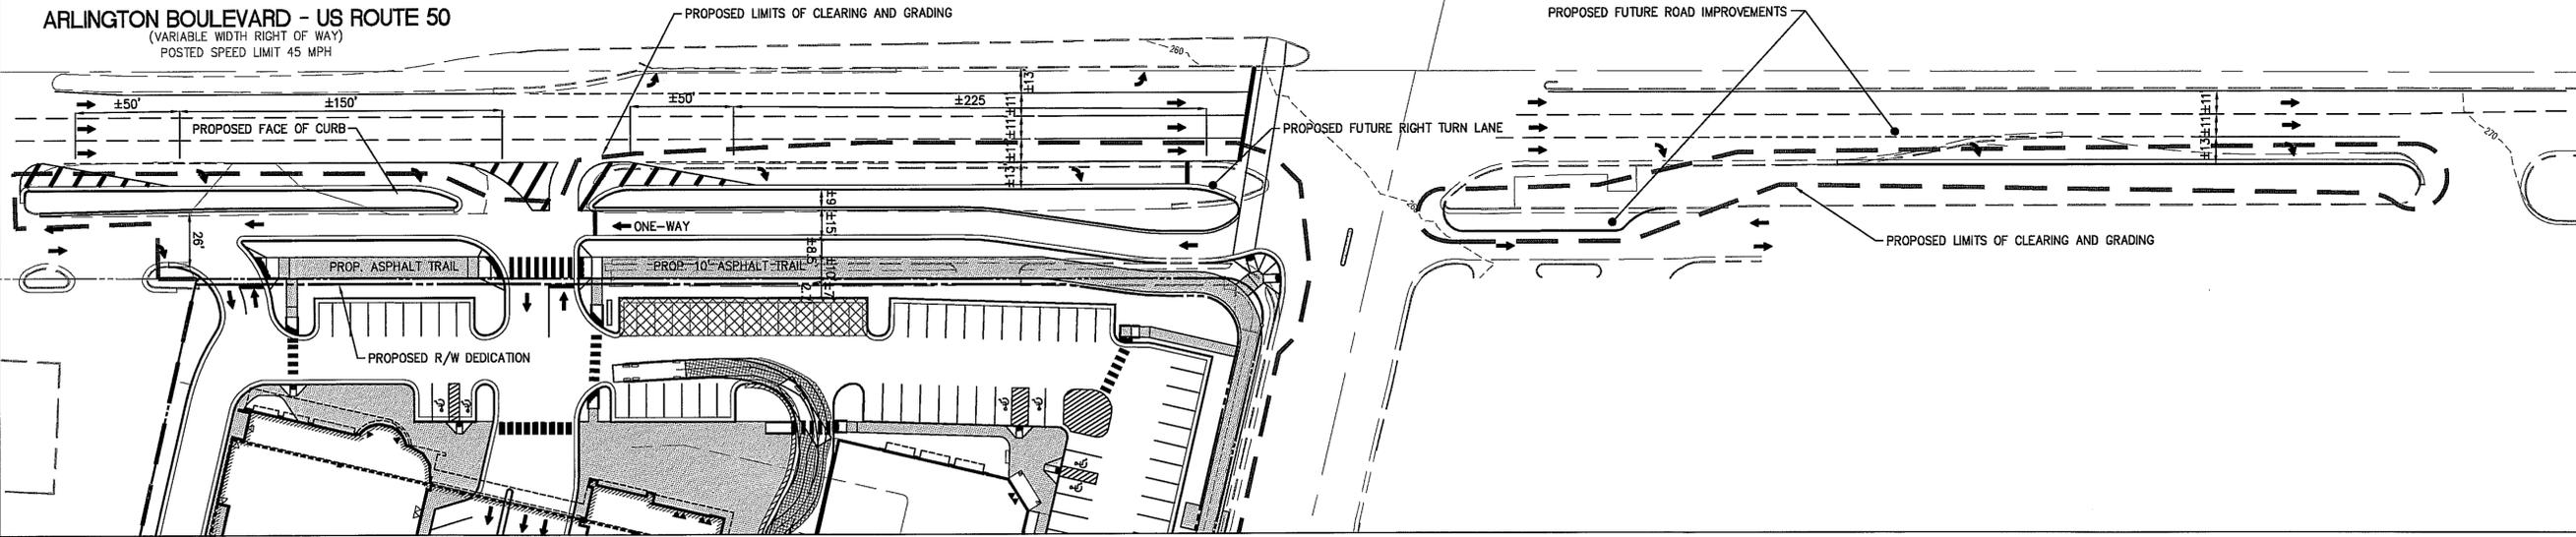

ARLINGTON BOULEVARD - ROUTE 50 OPTION A
(ONE-WAY WEST BOUND SERVICE DRIVE)
(SCALE: 1"=40')

ARLINGTON BOULEVARD - US ROUTE 50
(VARIABLE WIDTH RIGHT OF WAY)
POSTED SPEED LIMIT 45 MPH

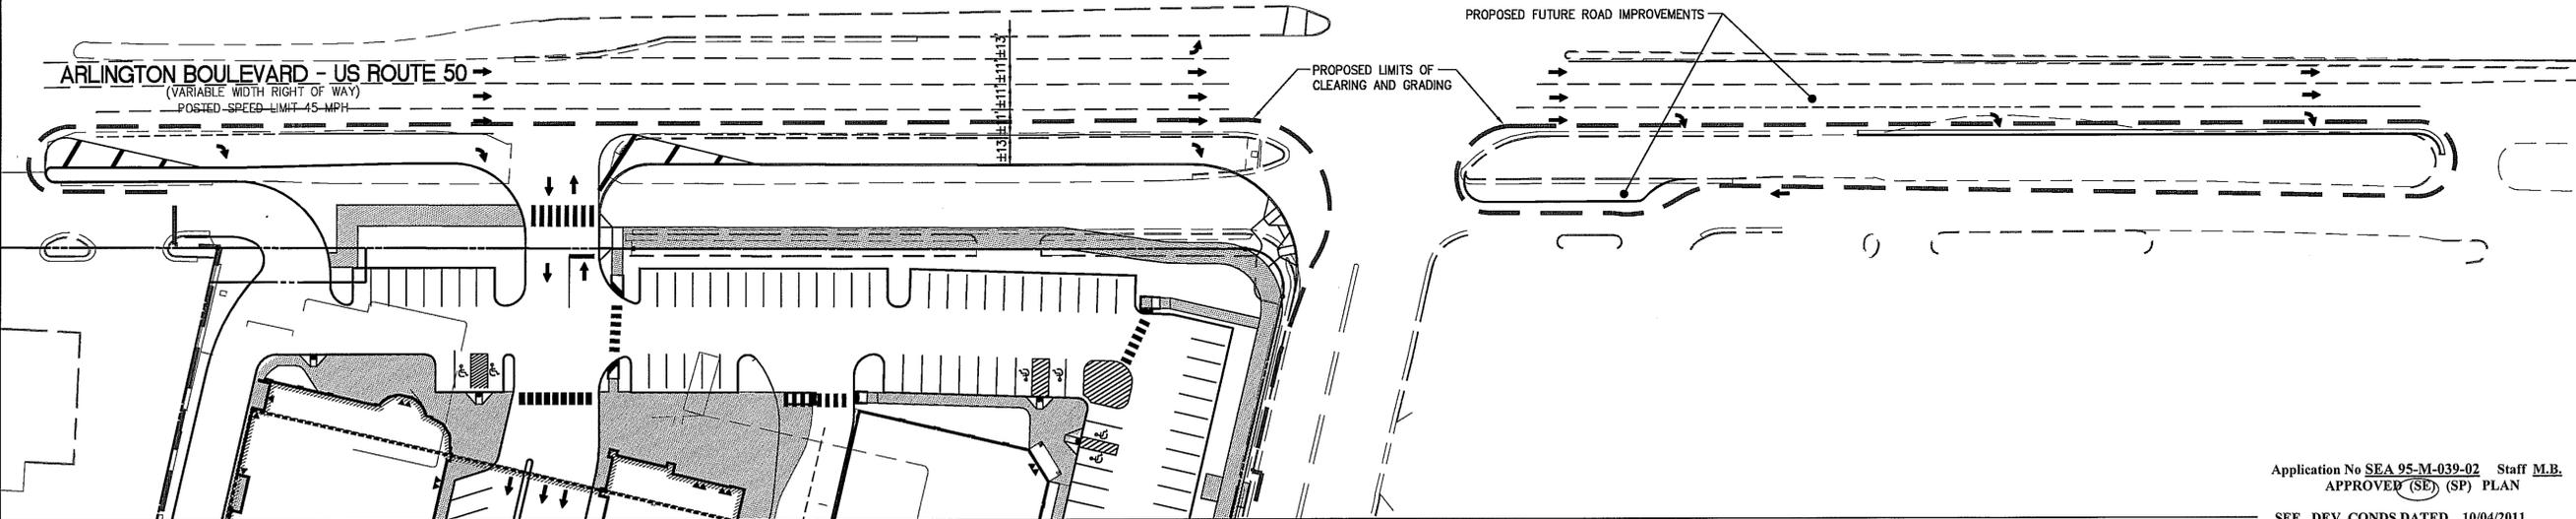

ARLINGTON BOULEVARD - ROUTE 50 OPTION B
(REMOVE EXISTING SERVICE DRIVE)
(SCALE: 1"=40')

Application No SEA 95-M-039-02 Staff M.B.
APPROVED (SE) (SP) PLAN

SEE DEV CONDS DATED 10/04/2011
Date of (BOS) (BZA) Approval 10/18/2011
Sheet 14 of 21

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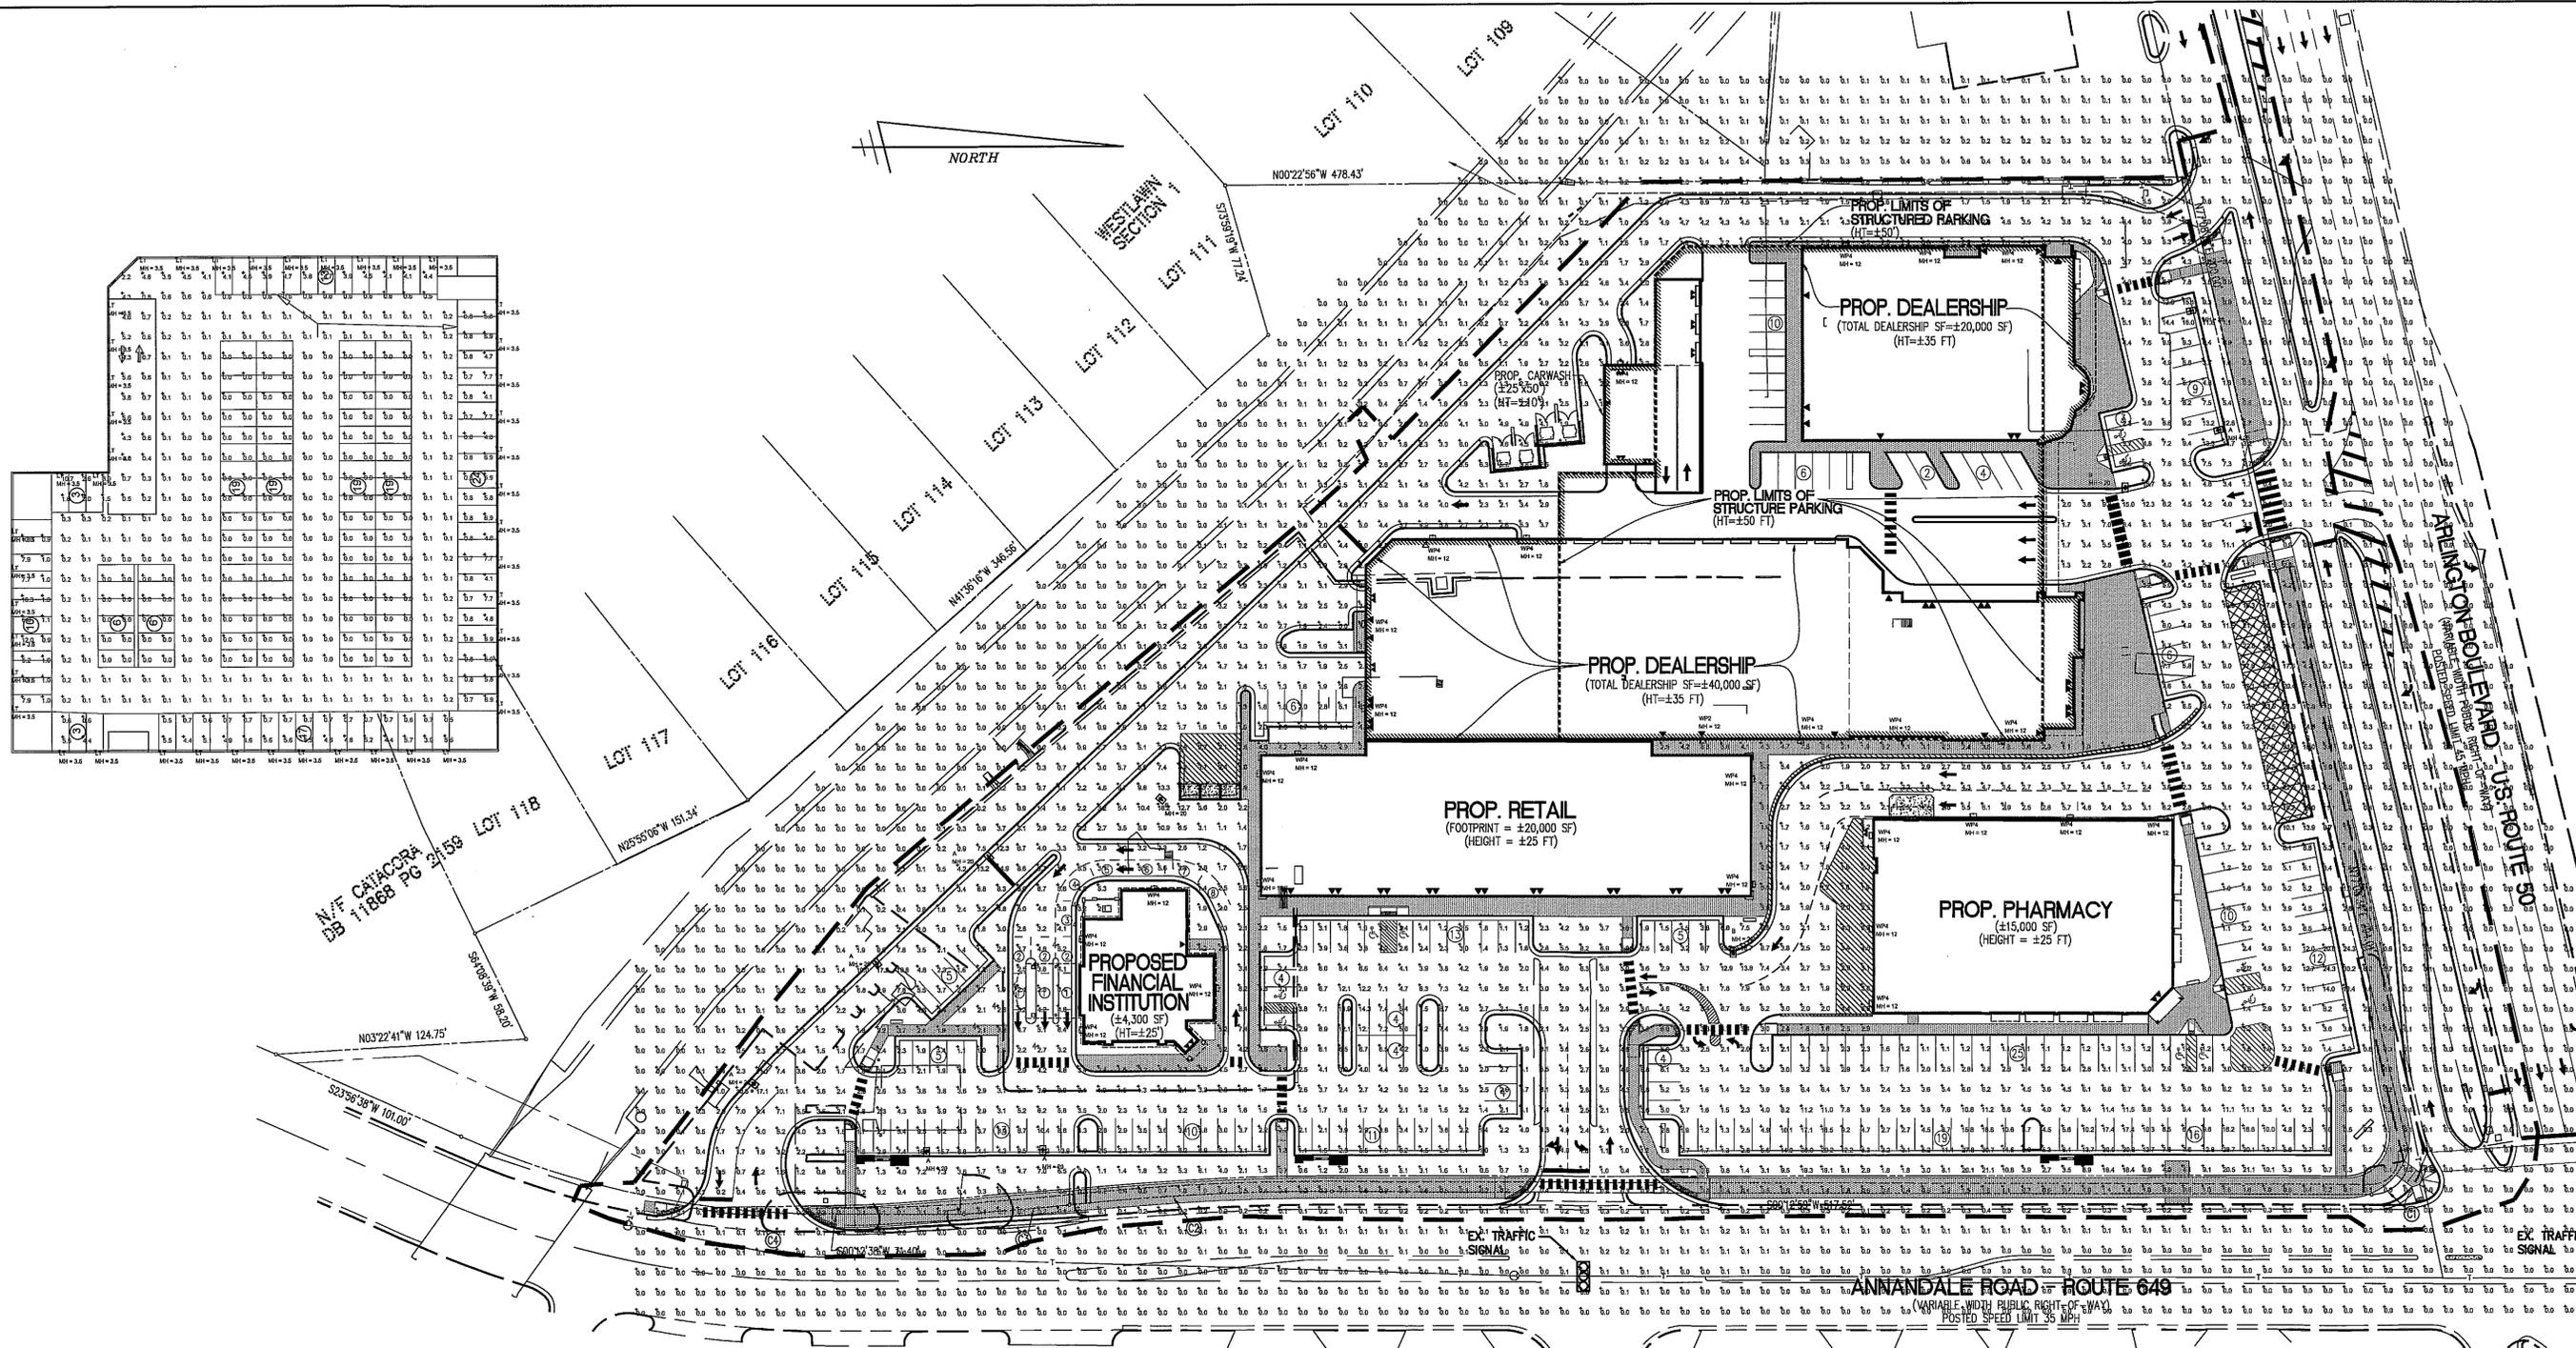
SITE DETAILS - ROUTE 50 IMPROVEMENTS

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FAIRFAX COUNTY, VIRGINIA



NO.	DESCRIPTION	DATE	REV. BY	APPROVED	DATE


WALTER L. PHILLIPS
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ESTABLISHED 1945
DATE: 5/11/11; REV: 7/28/2011; 9/18/2011; 9/20/11; 10/4/11
DRAWN: MRW
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FALLS CHURCH, VIRGINIA 22046
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Lot	Area	Value
109	Area 1	0.00
109	Area 2	0.00
109	Area 3	0.00
109	Area 4	0.00
109	Area 5	0.00
109	Area 6	0.00
109	Area 7	0.00
109	Area 8	0.00
109	Area 9	0.00
109	Area 10	0.00
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109	Area 20	0.00
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109	Area 97	0.00
109	Area 98	0.00
109	Area 99	0.00
109	Area 100	0.00

Symbol	Qty	Label	Arrangement	Total Lamp Lumens	LLF	Description	(FEST)
[Symbol]	7	A	SINGLE	40000	0.70	CM2-A-P40-H4-HS	L-10988
[Symbol]	5	A2	ROTATED OPTICS	40000	0.70	QTY 2 CM2-A-P40-H4-HS ROTATED OPTICS	L-10988
[Symbol]	3	B	SINGLE	40000	0.70	CM2-A-P40-H4	L-10987A
[Symbol]	7	C	SINGLE	40000	0.70	CM2-A-P40-HSP	L-10988
[Symbol]	1	C2	BACK-BACK	40000	0.70	QTY 2 CM2-A-P40-HSP	L-10988
[Symbol]	7	D	SINGLE	40000	0.70	CM2-A-P40-HSP-HS	L-10972
[Symbol]	5	D2	TWIN	40000	0.70	QTY 2 CM2-A-P40-HSP-HS	L-10972
[Symbol]	2	FL1	SINGLE	40000	0.70	POLARIS 12-SP2-400PMH-ED28	837431_ES
[Symbol]	2	FL2	SINGLE	40000	0.70	POLARIS 12-RM-400MH-ED28	837416_ES
[Symbol]	1	WP2	SINGLE	12600	0.70	WD1442150MH-ED17	KL00717
[Symbol]	25	WP4	SINGLE	12600	0.70	WD144150MH-ED17	KL00752
[Symbol]	45	LT	SINGLE	8000	0.70	LLF10150MH-ED17	17L3542

Label	Calc Type	Units	Avg	Max	Min	Avg/Mn	Max/Mn
CYLINDER_WALL_Total	Illuminance	Fc	0.00	0.0	0.0	N/A	N/A
TOP DECK	Illuminance	Fc	0.97	12.0	0.0	N/A	N/A
BANK	Illuminance	Fc	4.01	17.2	0.9	4.48	19.11
CAR DISPLAY FRONT LINE	Illuminance	Fc	19.99	23.5	10.1	1.98	2.33
CAR LOT	Illuminance	Fc	5.04	23.5	1.0	5.04	23.50
CUSTOMER PARKING CAR LOT	Illuminance	Fc	7.70	16.9	2.3	3.35	6.96
PHARMACY	Illuminance	Fc	5.15	30.9	1.0	5.15	30.90
RETAIL	Illuminance	Fc	3.91	16.7	1.0	3.91	16.70



Application No SEA 95-M-039-02 Staff M.B.
 APPROVED (SE) (SP) PLAN
 SEE DEV CONDS DATED 10/04/2011
 Date of (BOS) (BZA) Approval 10/18/2011
 Sheet 16 of 21
 Concurr. With PCA 2009-MA-011

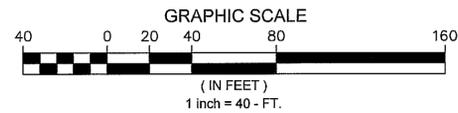
1. THIS LIGHTING DESIGN IS BASED ON LIMITED INFORMATION SUPPLIED BY OTHERS TO HUBBELL LIGHTING. SITE DETAILS PROVIDED HEREIN ARE REPRODUCED ONLY AS A VISUALIZATION AID. FIELD DEVIATIONS MAY SIGNIFICANTLY AFFECT PREDICTED PERFORMANCE. PRIOR TO INSTALLATION, CRITICAL SITE INFORMATION (POLE LOCATION, ORIENTATION, MOUNTING HEIGHT, ETC) SHOULD BE COORDINATED WITH THE CONTRACTOR AND/OR SPECIFIER RESPONSIBLE FOR THE PROJECT.
 2. LUMINAIRE DATA IS TESTED TO INDUSTRY STANDARDS UNDER LABORATORY CONDITIONS. OPERATING VOLTAGE AND NORMAL MANUFACTURING TOLERANCES OF LAMP, BALLAST, AND LUMINAIRE MAY AFFECT FIELD RESULTS.
 3. CONFORMANCE TO FACILITY CODE AND OTHER LOCAL REQUIREMENTS IS THE RESPONSIBILITY OF THE OWNER AND/OR THE OWNER'S REPRESENTATIVE.

TITLE:	PHOTOMETRIC PLAN		REVISED FROM DRAWING NUMBER(S):	0947005	1153858
	BILL PAGE HONDA			0947149	1153914
				1053708	1154027
				1153788	1154069

ON BY: ALU
 REV. BY: YWY
 DATE: 2-26-09
 DATE: 8-17-11
 QUOTE: N/A



CHK BY: N/A
 SCALE: AS NOTED
 DRAWING / DESIGN NO: 1155751-1

HUBBELL
 Hubbell Lighting, Inc.
 701 MILLENNIUM BLVD.
 GREENWICH, CT 06037

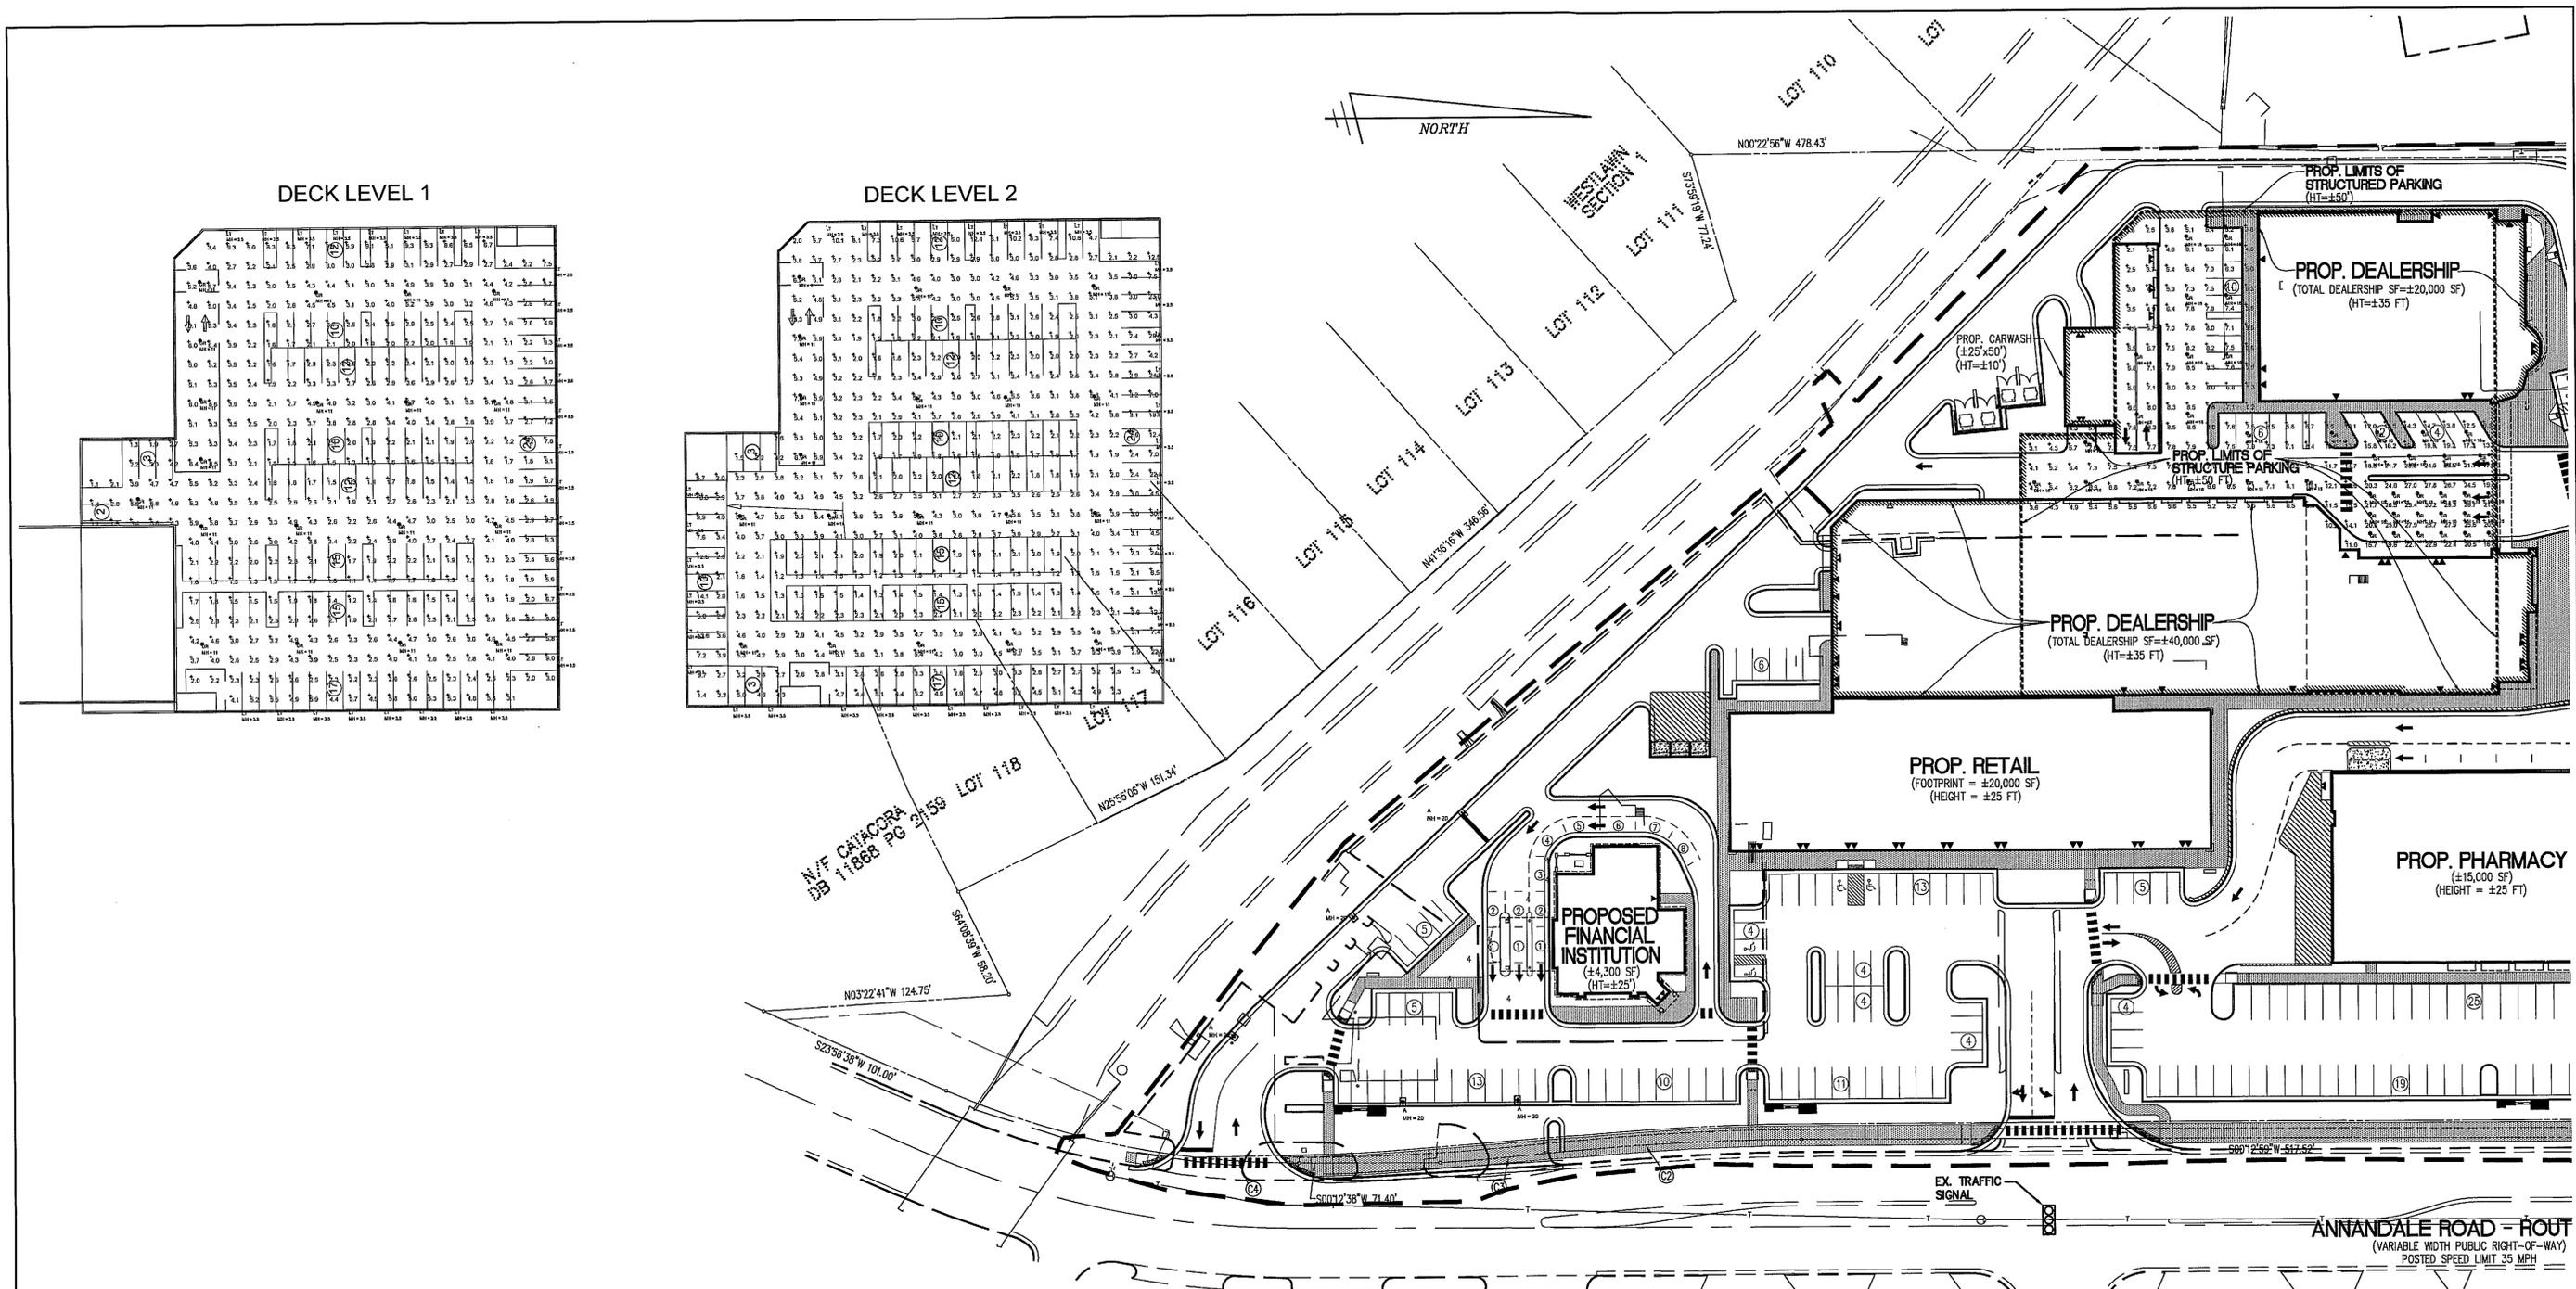

DECK LEVEL 1


DECK LEVEL 2

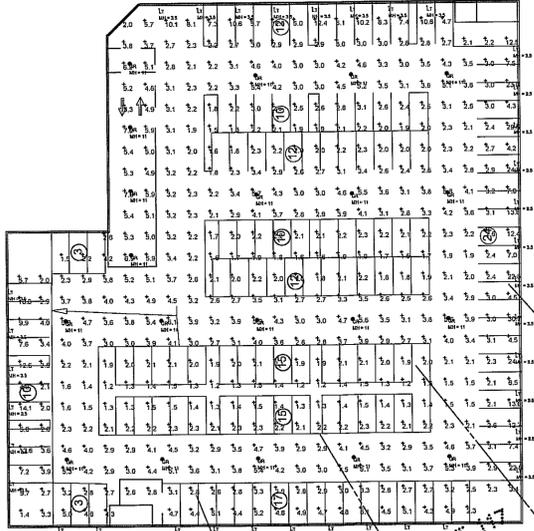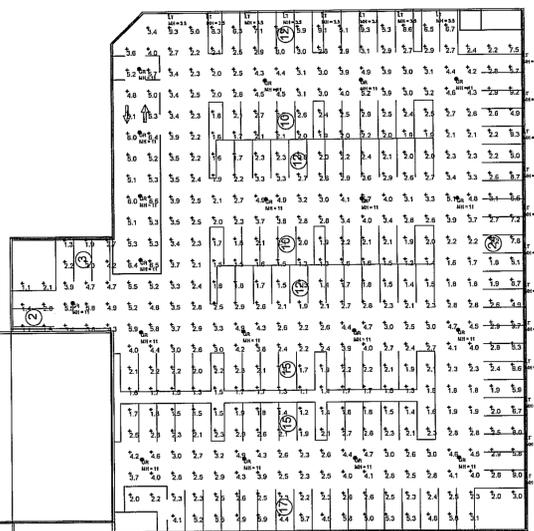

Symbol	Qty	Label	Arrangement	Total Lamp Lumens	LLF	Description	(TEST)
⊕	82	GR	SINGLE	15000	0.720	PGLS1175MH-ED17	KL00916
⊙	64	LT	SINGLE	8000	0.720	LLF10100MH-ED17	ITL33042

Room Summary	Wall Ht.	Description
BELOW DECK	17	
DECK LEVEL 1	12	REFLECTANCE 200/20
DECK LEVEL 2	11	REFLECTANCE 50/50

Label	CalcType	Units	Avg	Max	Min	Avg/Min	Max/Min
BELOW DECK_Floor	Illuminance	Fc	10.32	30.2	1.8	5.73	16.78
DECK LEVEL 1_Floor	Illuminance	Fc	3.24	9.7	1.1	2.95	8.82
DECK LEVEL 2_Floor	Illuminance	Fc	3.74	30.7	1.2	3.12	25.58
PARKING AND DRIVE BELOW DECK	Illuminance	Fc	8.80	15.6	1.8	3.78	8.87
UNDER CANOPY ENTRANCE	Illuminance	Fc	21.15	30.2	9.8	2.16	3.08

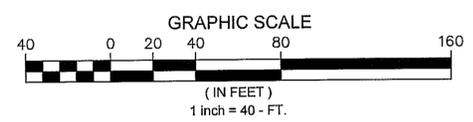


Application No SEA 95-M-039-02 Staff M.B.
 APPROVED (SE) (SP) PLAN
 SEE DEV CONDS DATED 10/04/2011
 Date of (BOS) (BZA) Approval 10/18/2011
 Sheet 17 of 21
 Concurr. With PCA 2009-MA-011

1. THIS LIGHTING DESIGN IS BASED ON LIMITED INFORMATION SUPPLIED BY OTHERS TO HUBBELL LIGHTING. SITE DETAILS PROVIDED HEREON ARE REPRODUCED ONLY AS A VISUALIZATION AND FIELD DEVIATIONS MAY SIGNIFICANTLY AFFECT PREDICTED PERFORMANCE. PRIOR TO INSTALLATION, CRITICAL SITE INFORMATION (POLE LOCATIONS, ORIENTATION, MOUNTING HEIGHT, ETC.) SHOULD BE COORDINATED WITH THE CONTRACTOR AND/OR SPECIFIER RESPONSIBLE FOR THE PROJECT.
 2. LUMINAIRE DATA IS TESTED TO INDUSTRY STANDARDS UNDER LABORATORY CONDITIONS. OPERATING VOLTAGE AND NORMAL MANUFACTURING TOLERANCES OF LAMP, BALLAST, AND LUMINAIRE MAY AFFECT FIELD RESULTS.
 3. CONFORMANCE TO FACILITY CODE AND OTHER LOCAL REQUIREMENTS IS THE RESPONSIBILITY OF THE OWNER AND/OR THE OWNER'S REPRESENTATIVE.


TITLE:	PHOTOMETRIC PLAN BILL PAGE HONDA	REVISION FROM DRAWING NUMBER(S):	0947005 1153858 0947149 1153914 1053708 1154027 1153788 1154069	HUBBELL Hubbell Lighting, Inc. 701 MILLENIUM BLVD. GREENVILLE, SC 29607	DN BY: ALU REV BY: YWW QUOTE: N/A	DATE: 2-26-09 DATE: 8-17-11 DRAWING/DESIGN NO.:	CHK BY: N/A SCALE: AS NOTED 1155751-2
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THIS DRAWING AND THE PROPERTY OF THE ARCHITECT AND NOT BE LOANED, REPRODUCED, COPIED, OR IN ANY MANNER USED FOR ANY PURPOSE WITHOUT THE WRITTEN CONSENT OF THE ARCHITECT.

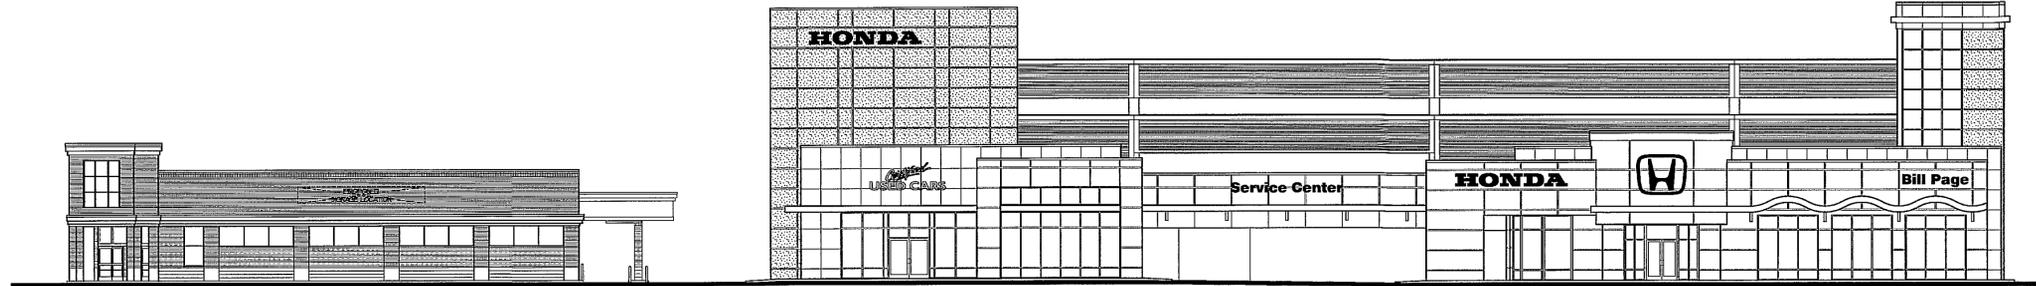


ARLINGTON BOULEVARD (NORTH) ELEVATION

SCALE: 3/32" = 1'-0"

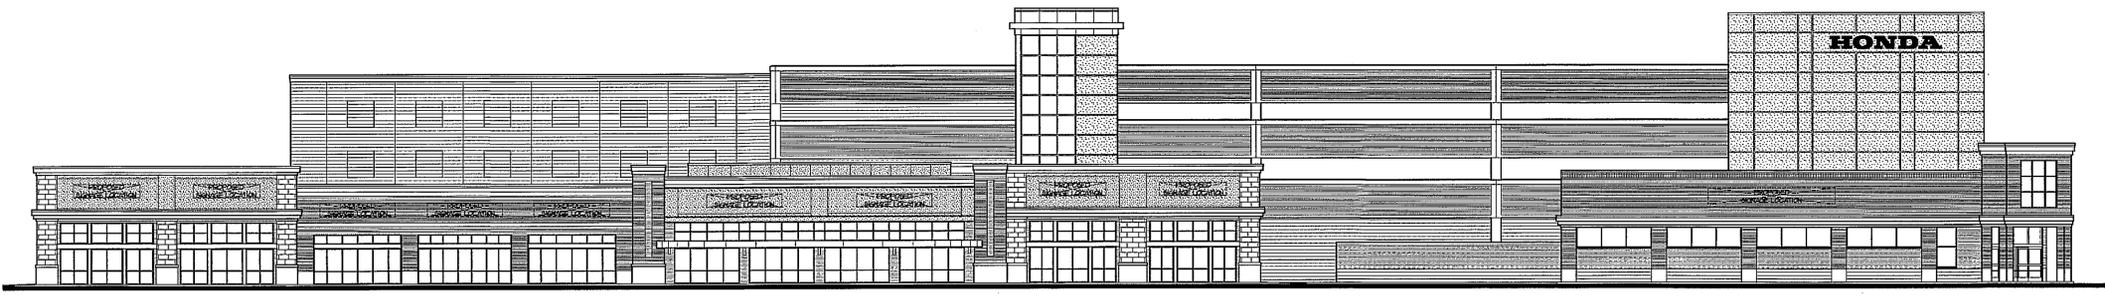


ANNANDALE ROAD (EAST) ELEVATION

SCALE: 3/32" = 1'-0"

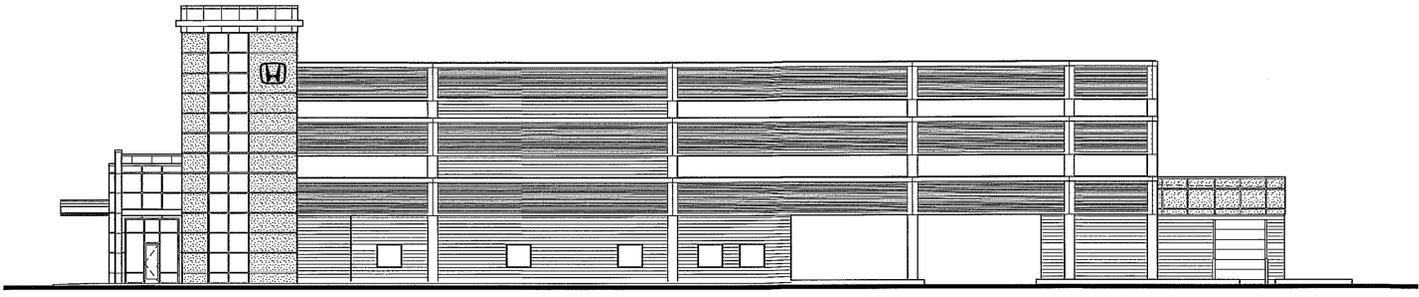


RIGHT SIDE (WEST) ELEVATION

SCALE: 3/32" = 1'-0"

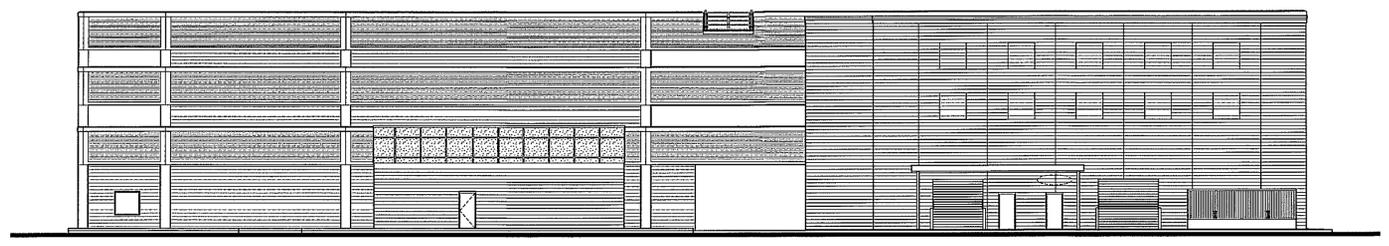

REAR (SOUTH) ELEVATION

SCALE: 3/32" = 1'-0"

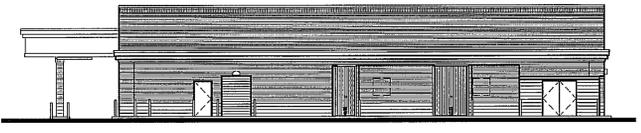

PHARMACY (SOUTH) REAR ELEVATION

SCALE: 3/32" = 1'-0"

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**FREEMAN
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TEL (804) 282-9790
FAX (804) 282-2227

EXTERIOR ELEVATIONS
BILL PAGE HONDA at WESTLAWN CENTER
ARLINGTON BOULEVARD & ANNANDALE ROAD
FALLS CHURCH, VIRGINIA

Job 1088
Date 08-15-11
Sheet No. **A3.1**
01 of 02

FOR ILLUSTRATIVE PURPOSES ONLY

RESIDENCE
LOT 117

ANNANDALE ROAD (EAST) ELEVATION

SCALE: 1/8" = 1'-0"

RESIDENCE
LOT 112

LEFT SIDE (SOUTH) ELEVATION

SCALE: 1/8" = 1'-0"

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Revisions

LINE OF SIGHT
BILL PAGE HONDA
ARLINGTON BOULEVARD & ANNANDALE ROAD
FALLS CHURCH, VIRGINIA

FOR ILLUSTRATIVE PURPOSES ONLY

Application No SEA 95-M-039-02 Staff M.B.
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Job
0787


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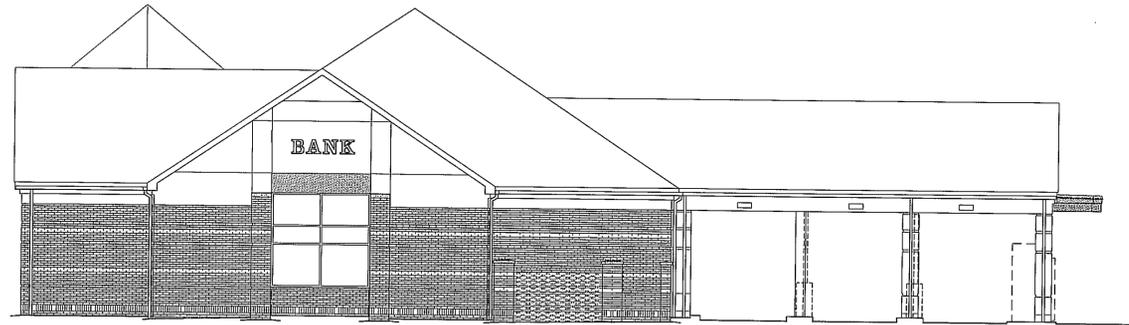
A3.2

15 OF 17

SHEET 19 OF 21




1E BUILDING ELEVATION
1/8" = 1'-0" 04120-01E004.DWG

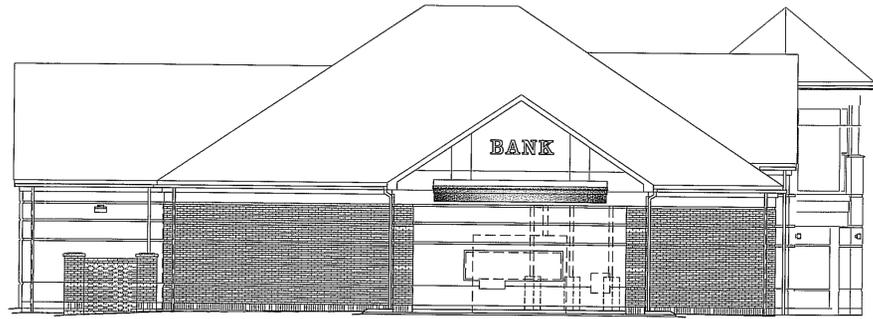

5E BUILDING ELEVATION
1/8" = 1'-0" 04120-01E003.DWG



1G BUILDING ELEVATION
1/8" = 1'-0" 04120-01E002.DWG

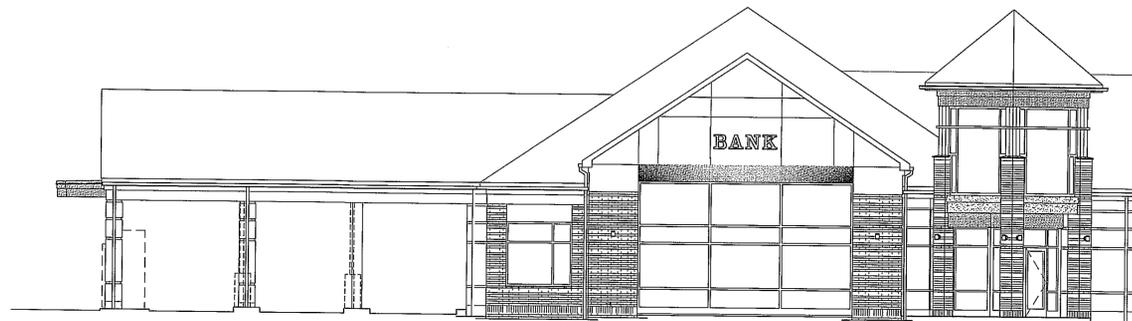

5G BUILDING ELEVATION
1/8" = 1'-0" 04120-01E001.DWG

FOR ILLUSTRATIVE PURPOSES ONLY

FINANCIAL INSTITUTION ELEVATIONS

Application No SEA 95-M-039-02 Staff M.B.
 APPROVER (SE) (SP) PLAN
 SEE DEV CONDS DATED 10/04/2011
 Date of (BOS) (BZA) Approval 10/18/2011
 Sheet 20 of 21
 Concurr. With PCA 2009-MA-011



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WESTLAWN CENTER

ARLINGTON BOULEVARD & ANNANDALE ROAD
FALLS CHURCH, VIRGINIA

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